
TOWN OF WETHERSFIELD DEPARTMENT OF PUBLIC WORKS ENGINEERING DIVISION

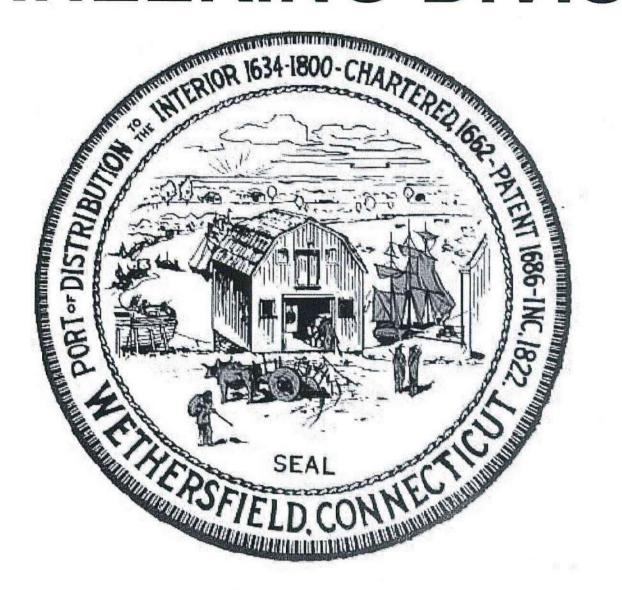


DESIGNED BY:
TOWN OF WETHERSFIELD
ENGINEERING DIVISION

DERRICK D. GREG TOWN ENGINEER P.E. No. 22304


ADDDOVED BY:

FREDERICK J. PRESLEY TOWN MANAGER


COMMUNITY CONNECTIVITY GRANT PROGRAM OLD WETHERSFIELD SAFETY IMPROVEMENTS MAY 2022

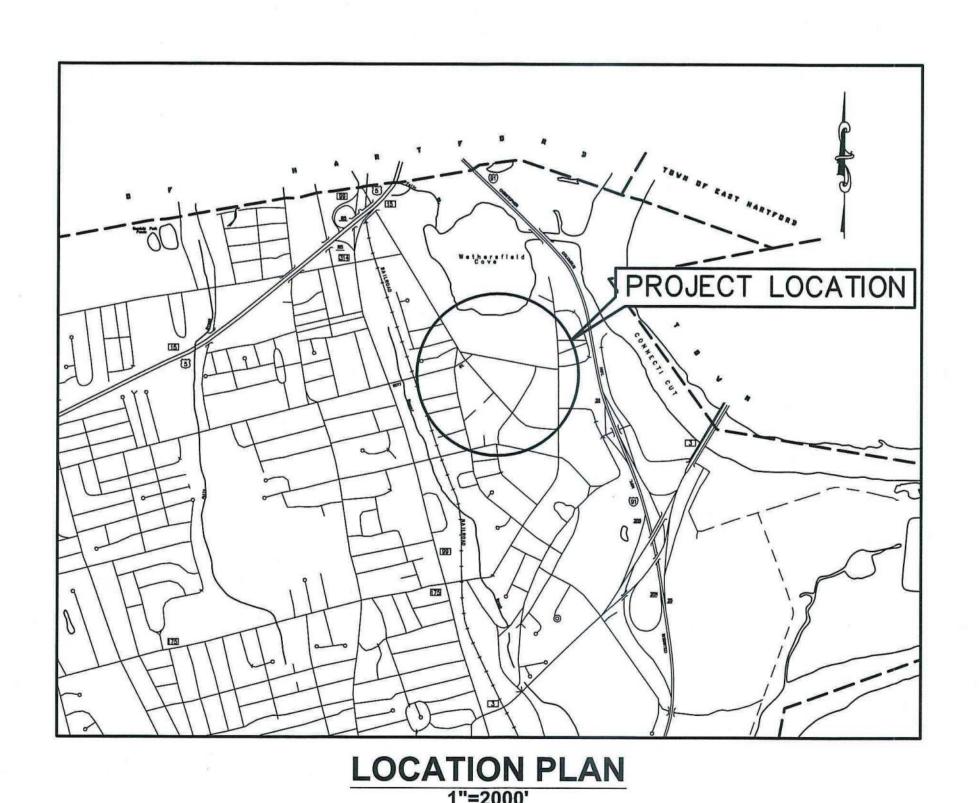



LIST OF DRAWINGS						
SHEET No.	SHEET TITLE					
1	COVER SHEET					
2	INDEX PLAN					
3	SITE A - EXISTING CONDITIONS PLAN - MAIN ST & HARTFORD AV					
4	SITE B — EXISTING CONDITIONS PLAN — GARDEN ST & NOTT ST					
5	SITE C - EXISTING CONDITIONS PLAN - MAIN ST & STATE ST					
6	SITE A - SITE PLAN - MAIN ST & HARTFORD AVE					
7	SITE B - SITE PLAN - GARDEN ST & NOTT ST					
8	SITE C - SITE PLAN - MAIN ST & STATE ST					
9	CONSTRUCTION DETAILS 1					
10	CONSTRUCTION DETAILS 2					
11	CONSTRUCTION DETAILS 3					
12	CONSTRUCTION DETAILS 4					

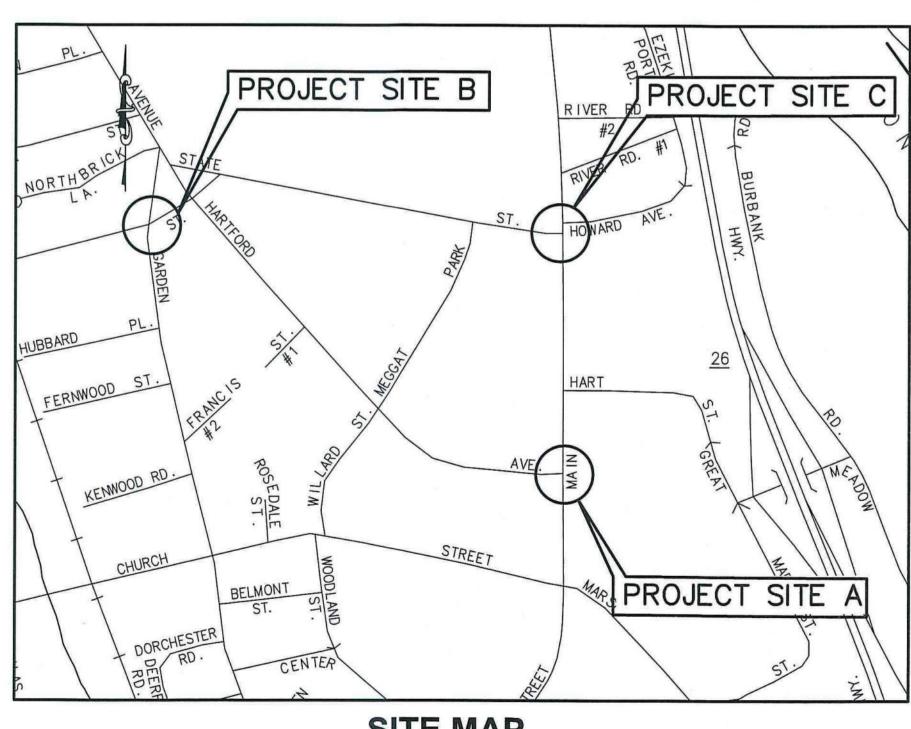

SITE MAP

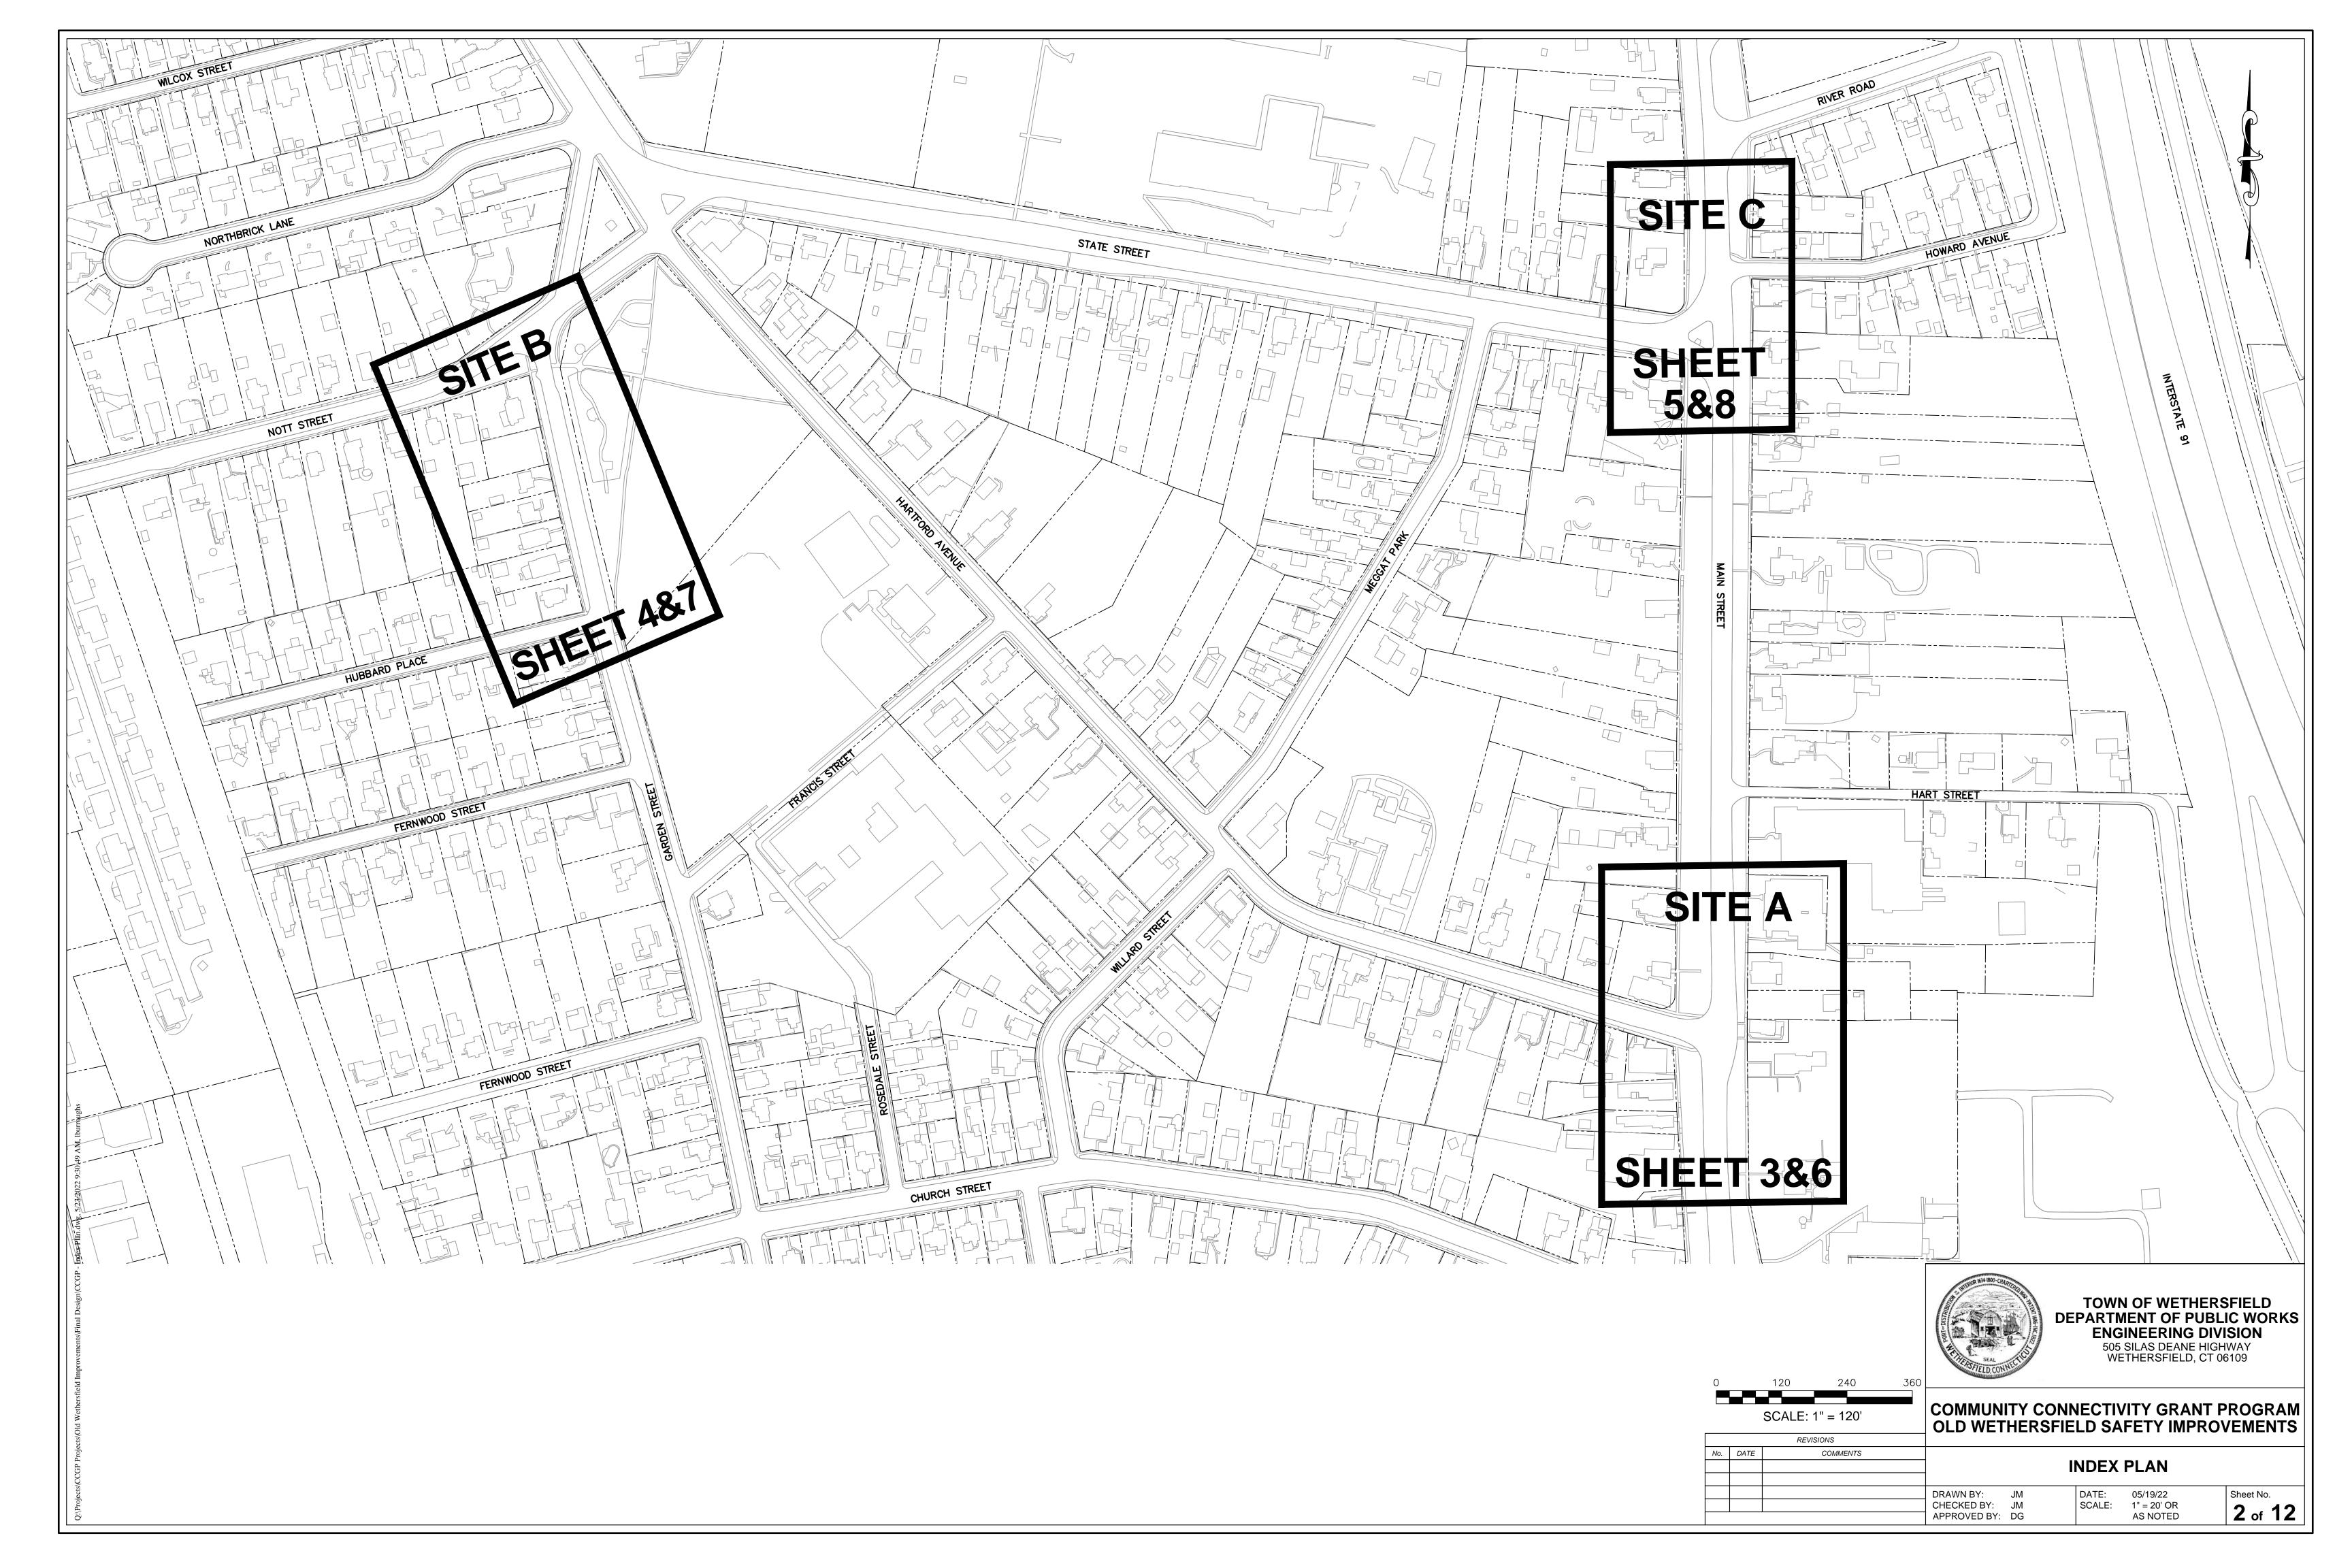

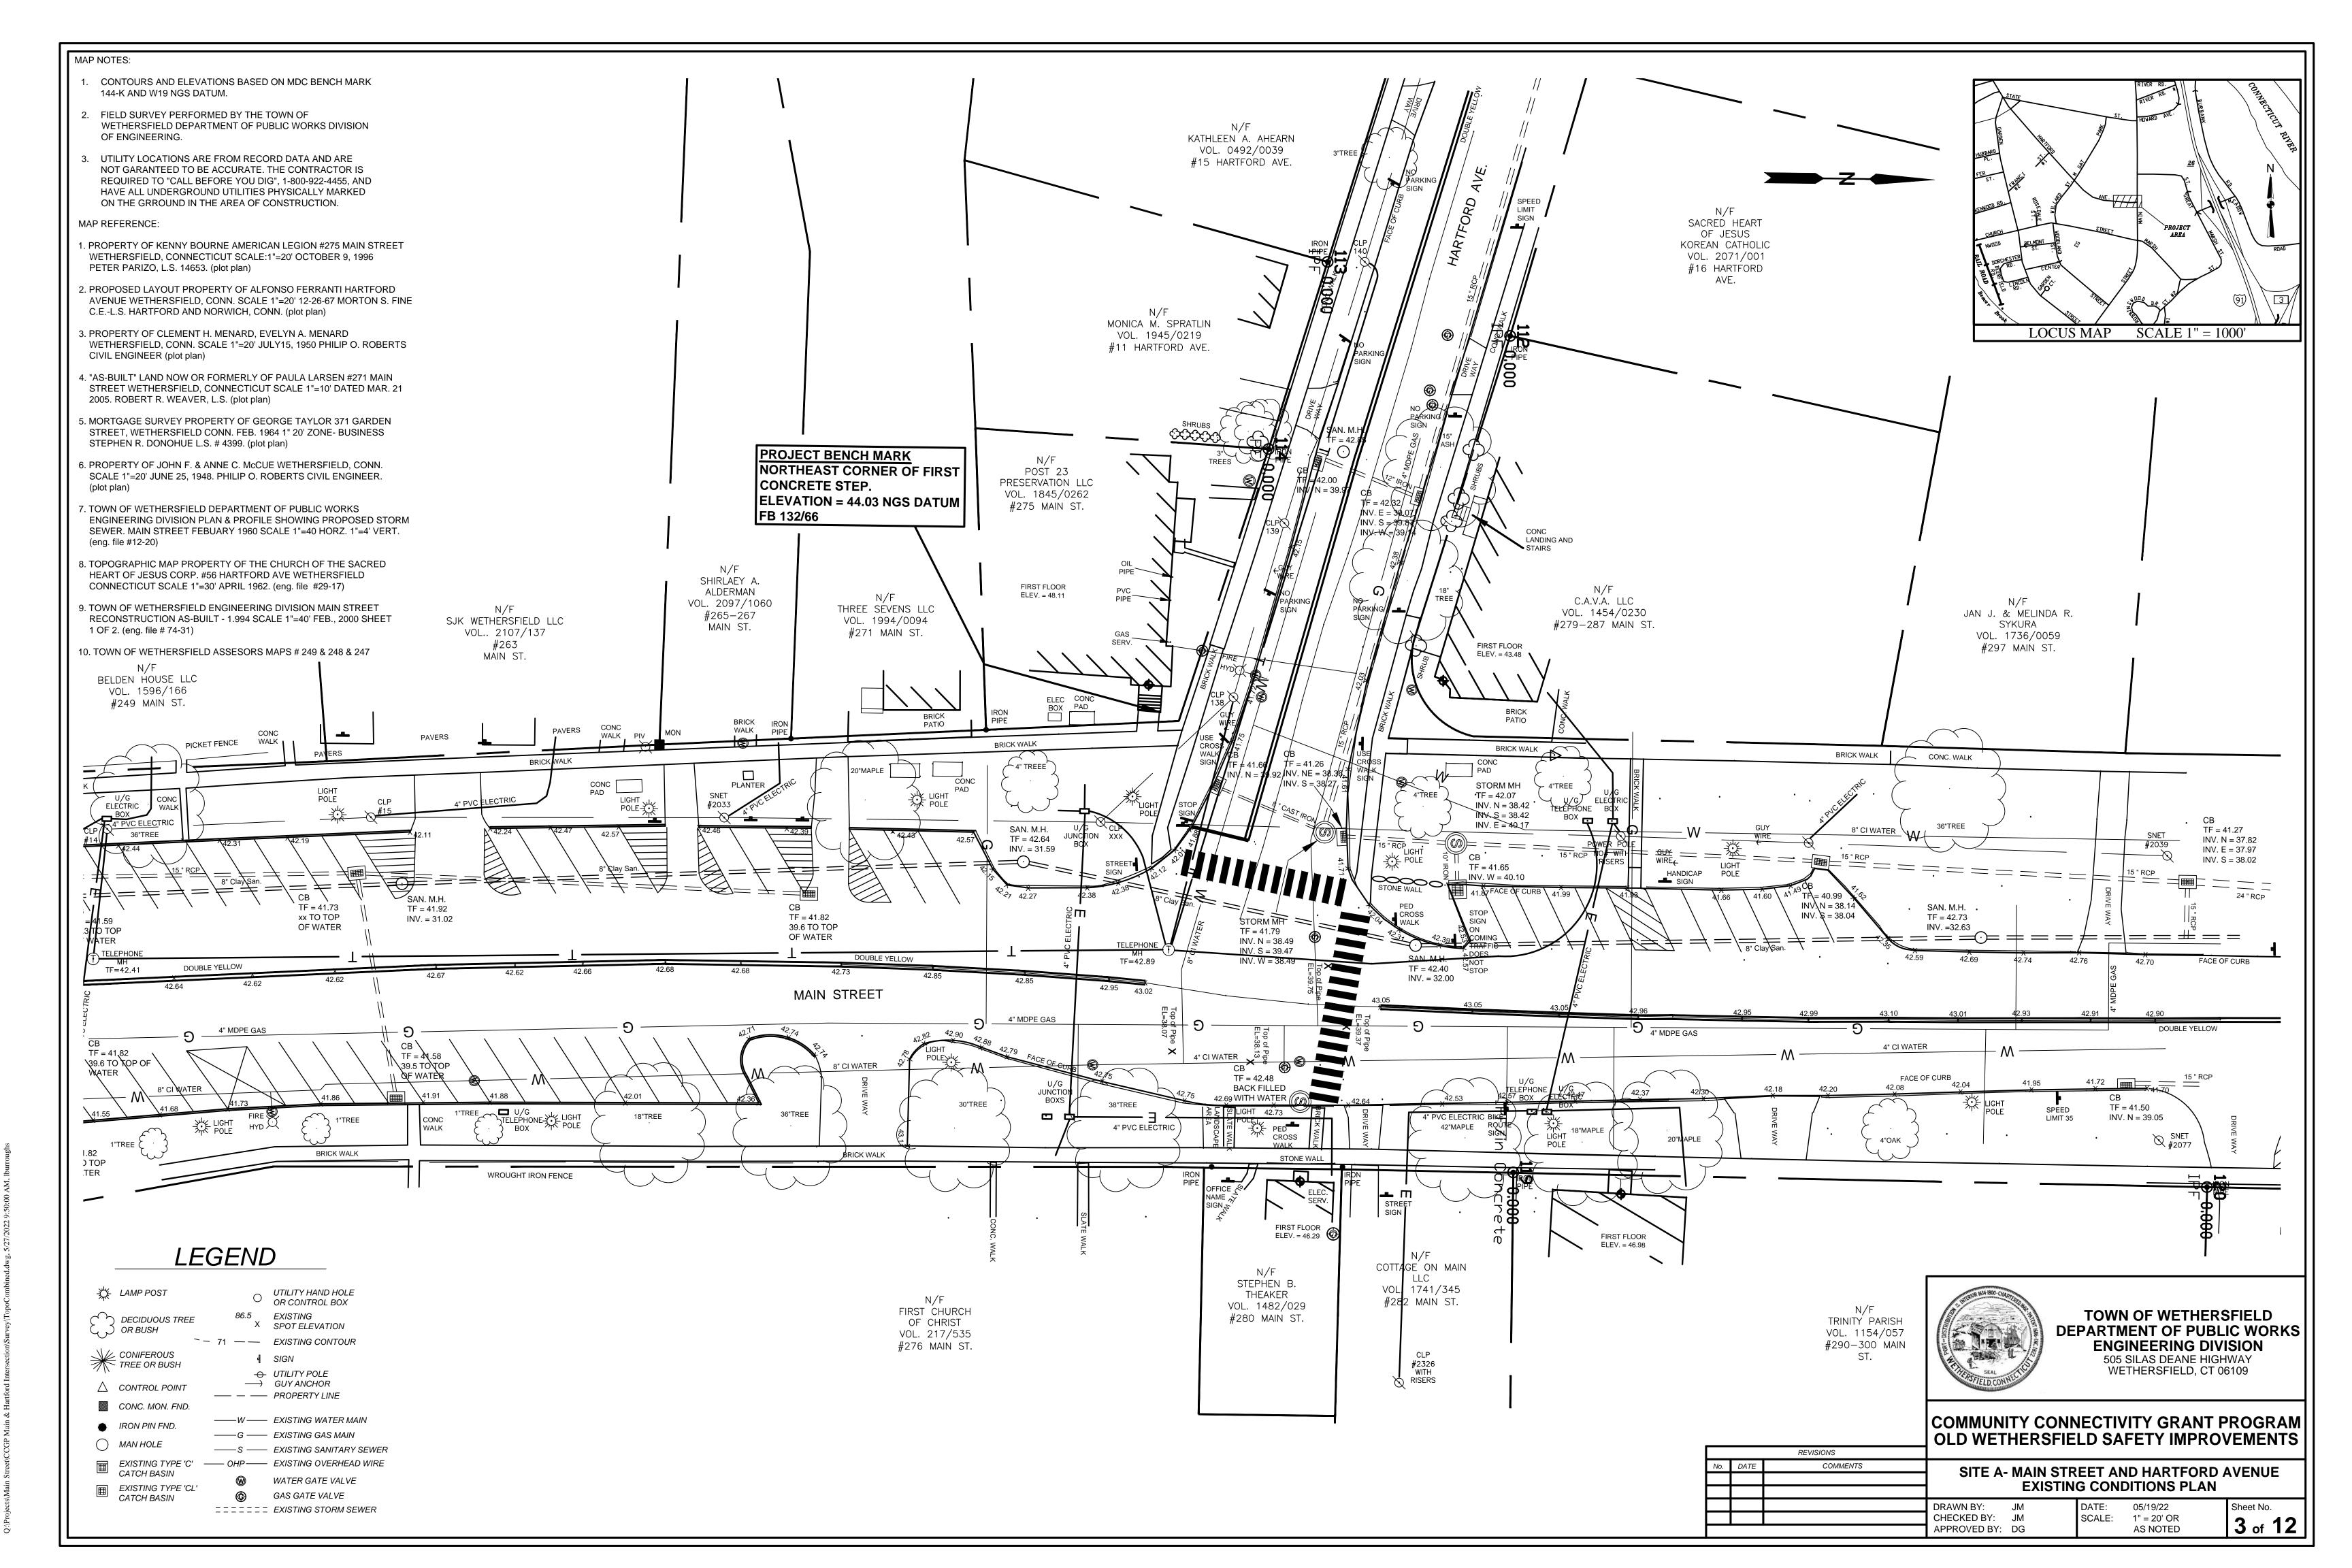


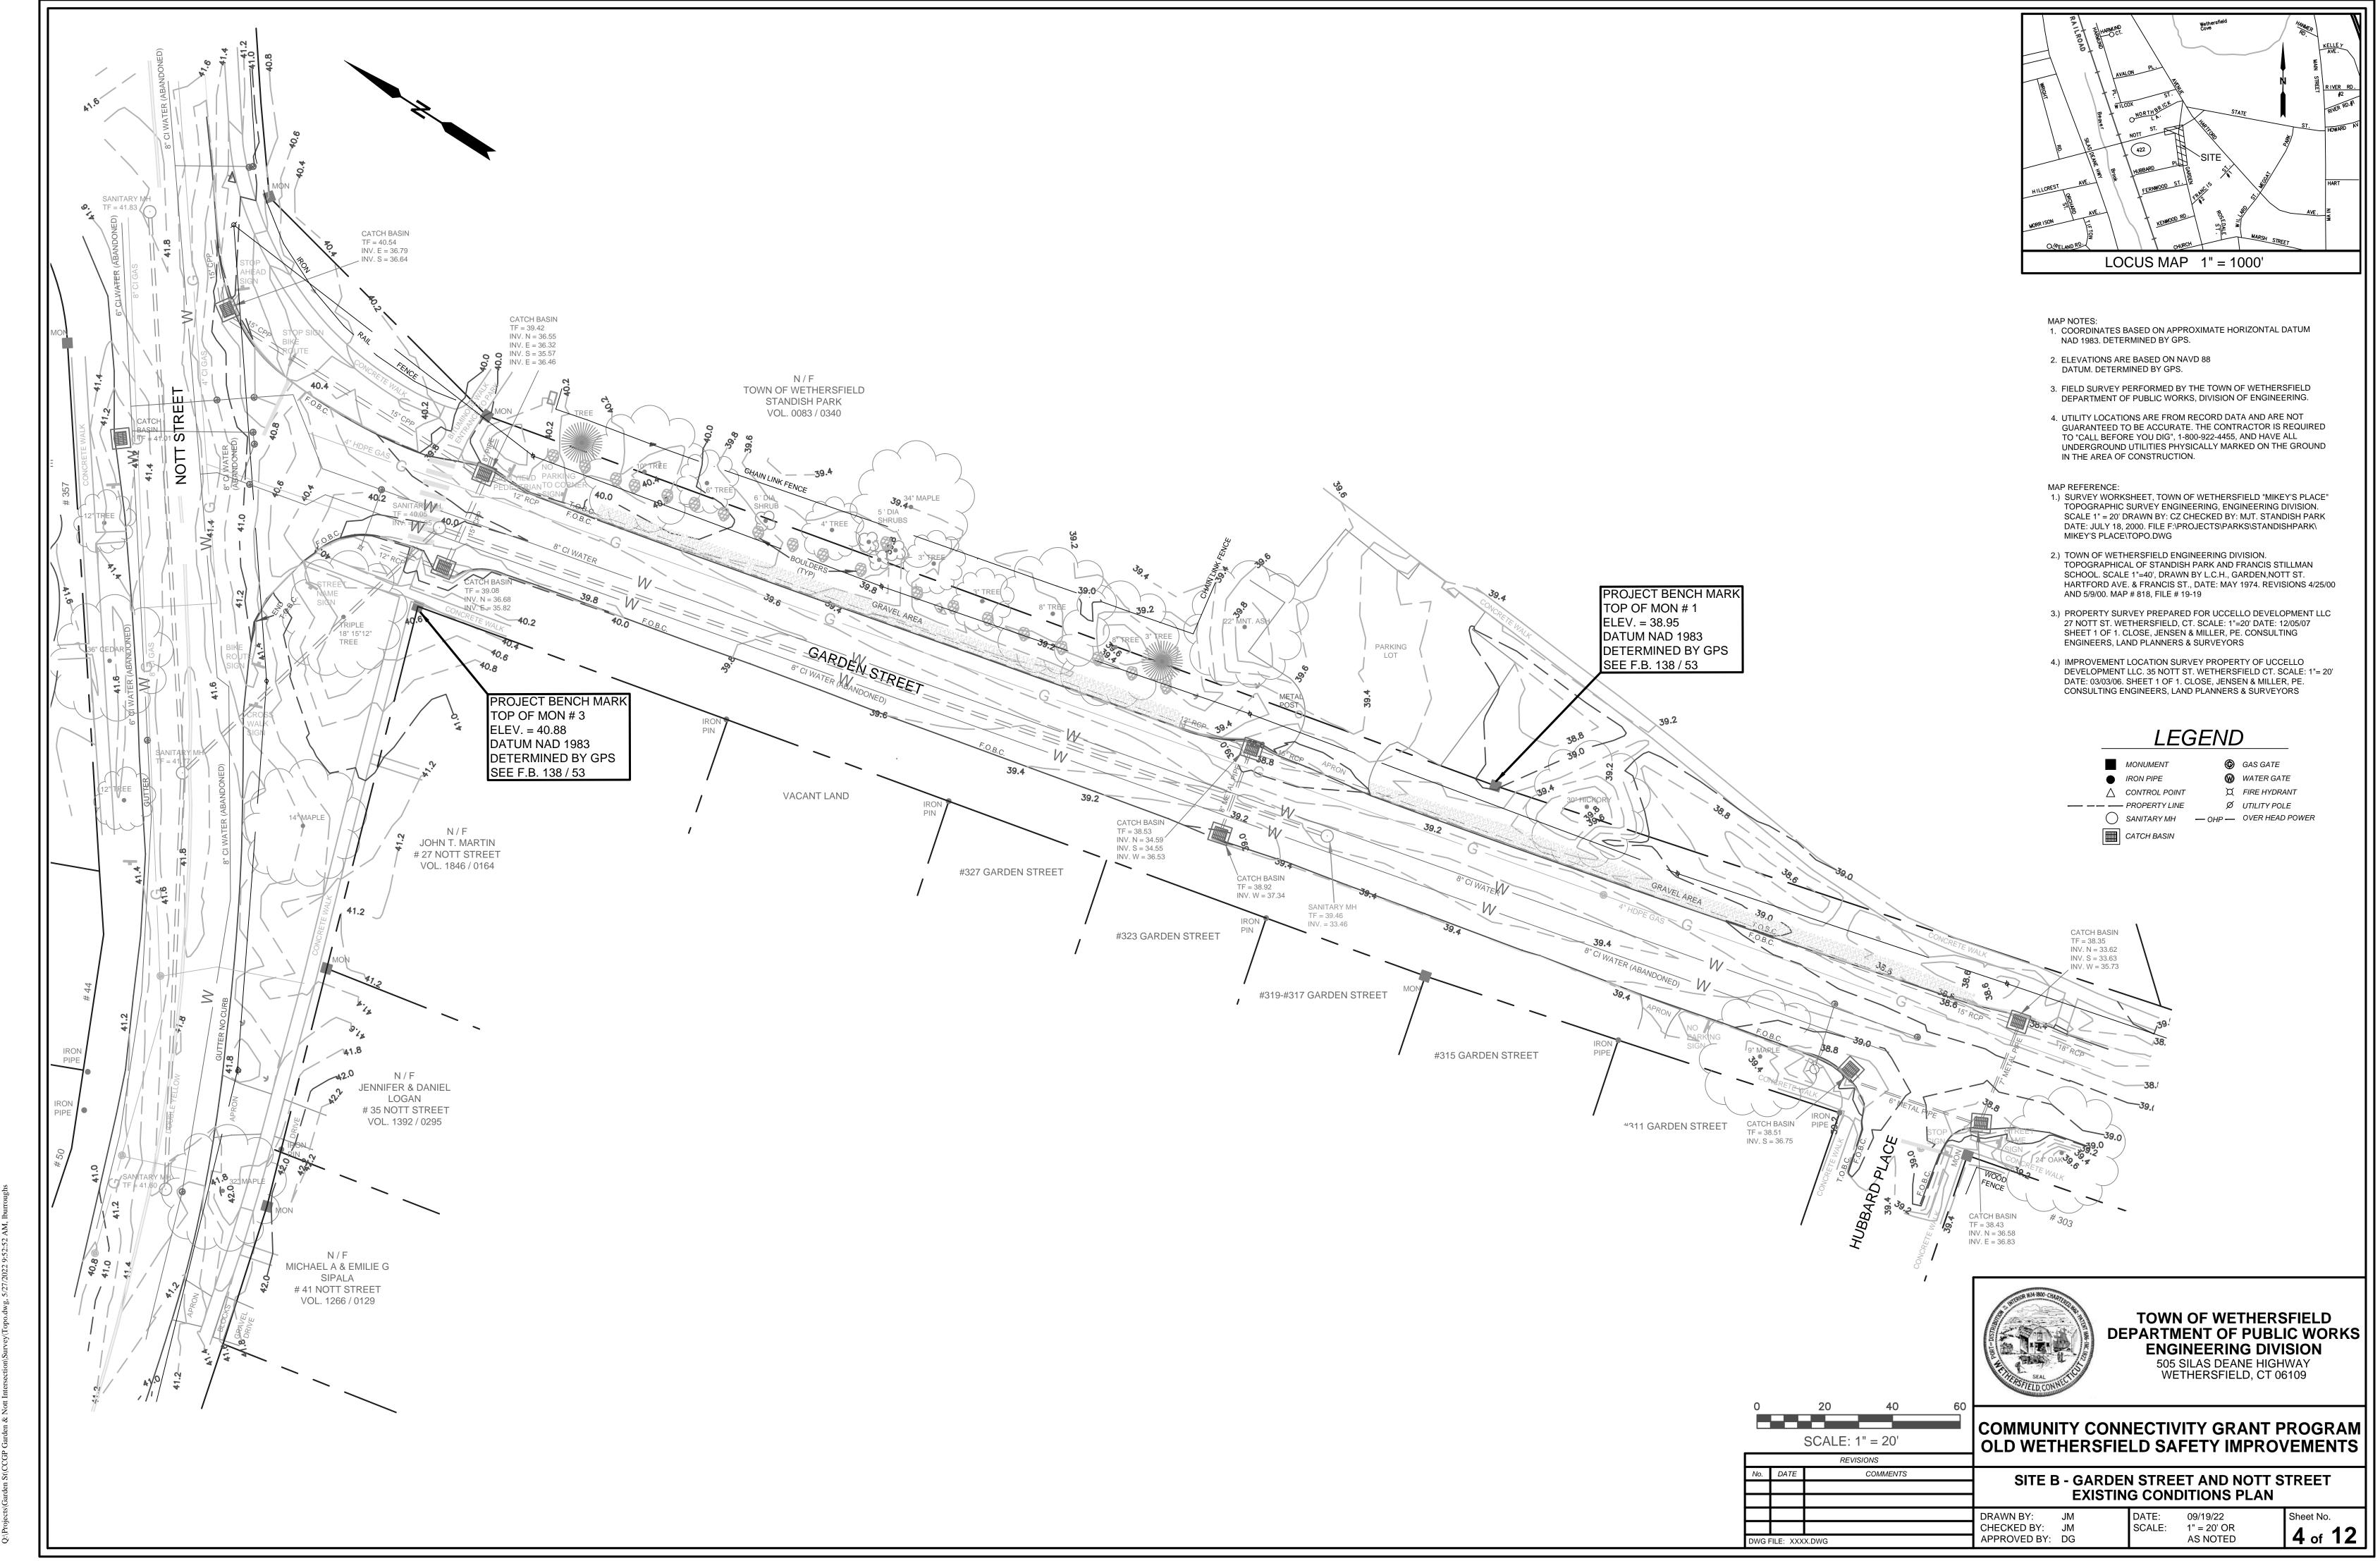



O.\Proiects\Garden St\CCGP Garden & Nott Intersection\Survev\Tono dwg 5/77/2029-5





·Projects\Main Street\CCCP Main & State Intersection\Survey\TonoCombined dwo 5/24/20

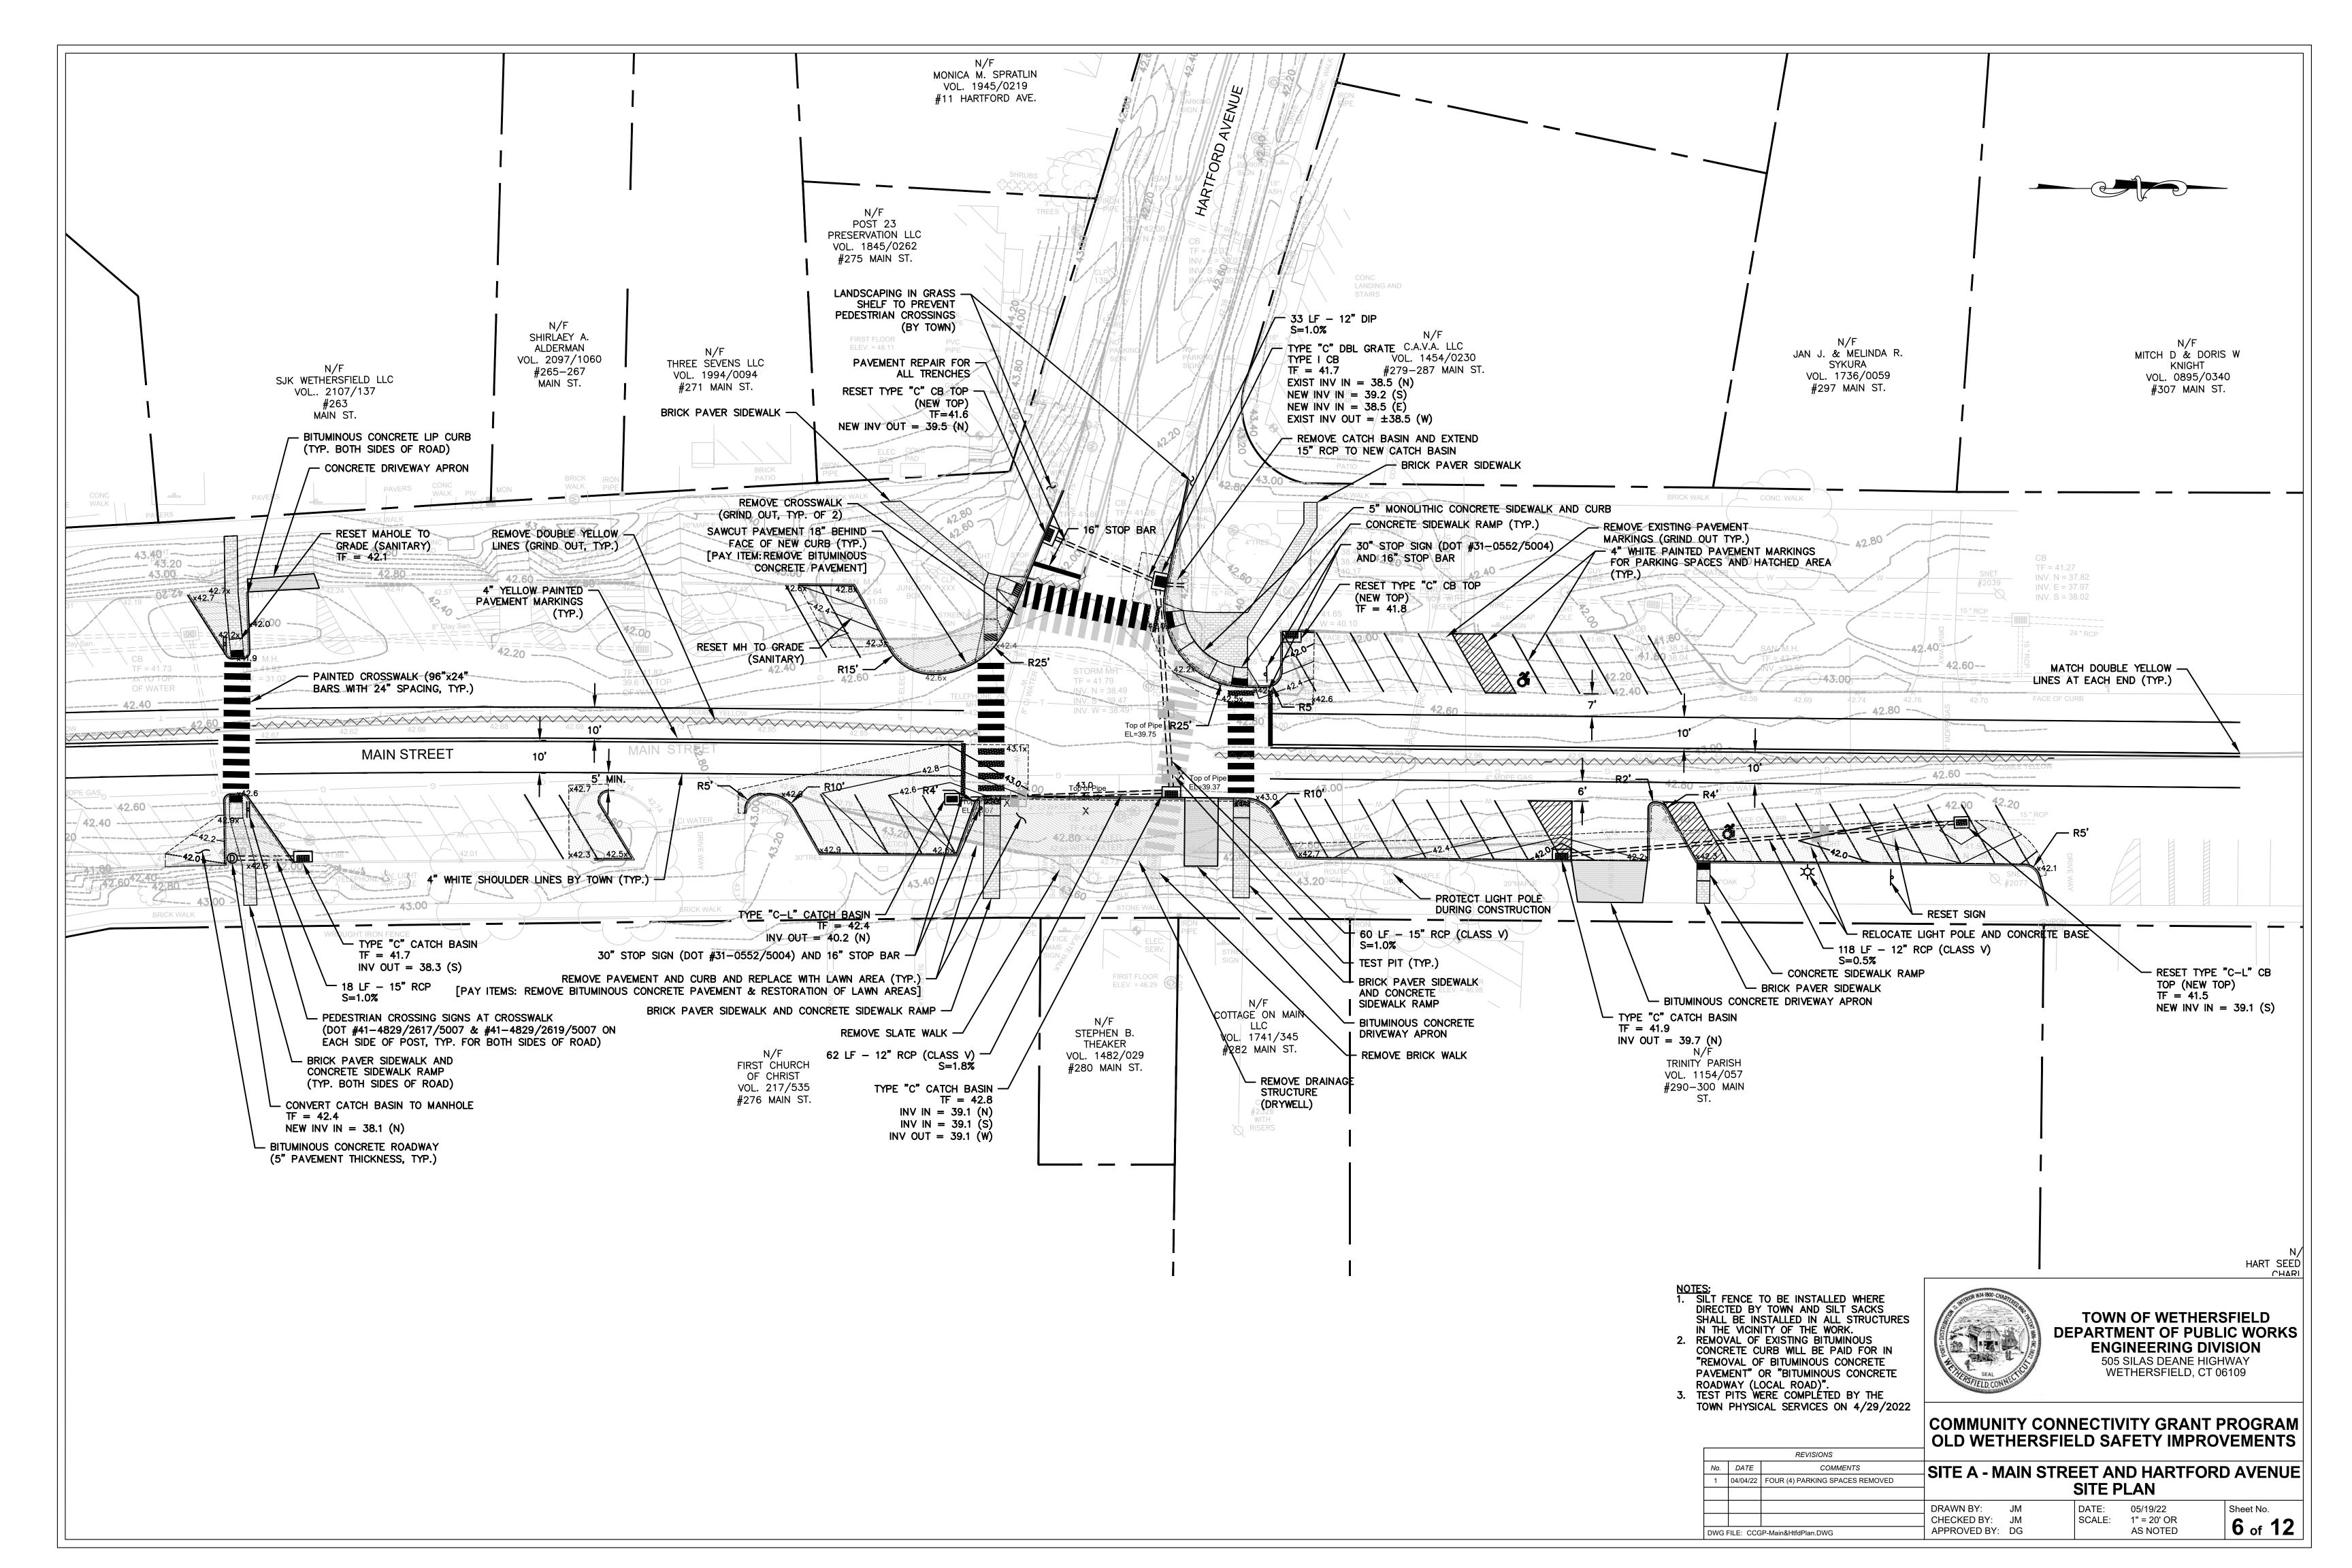

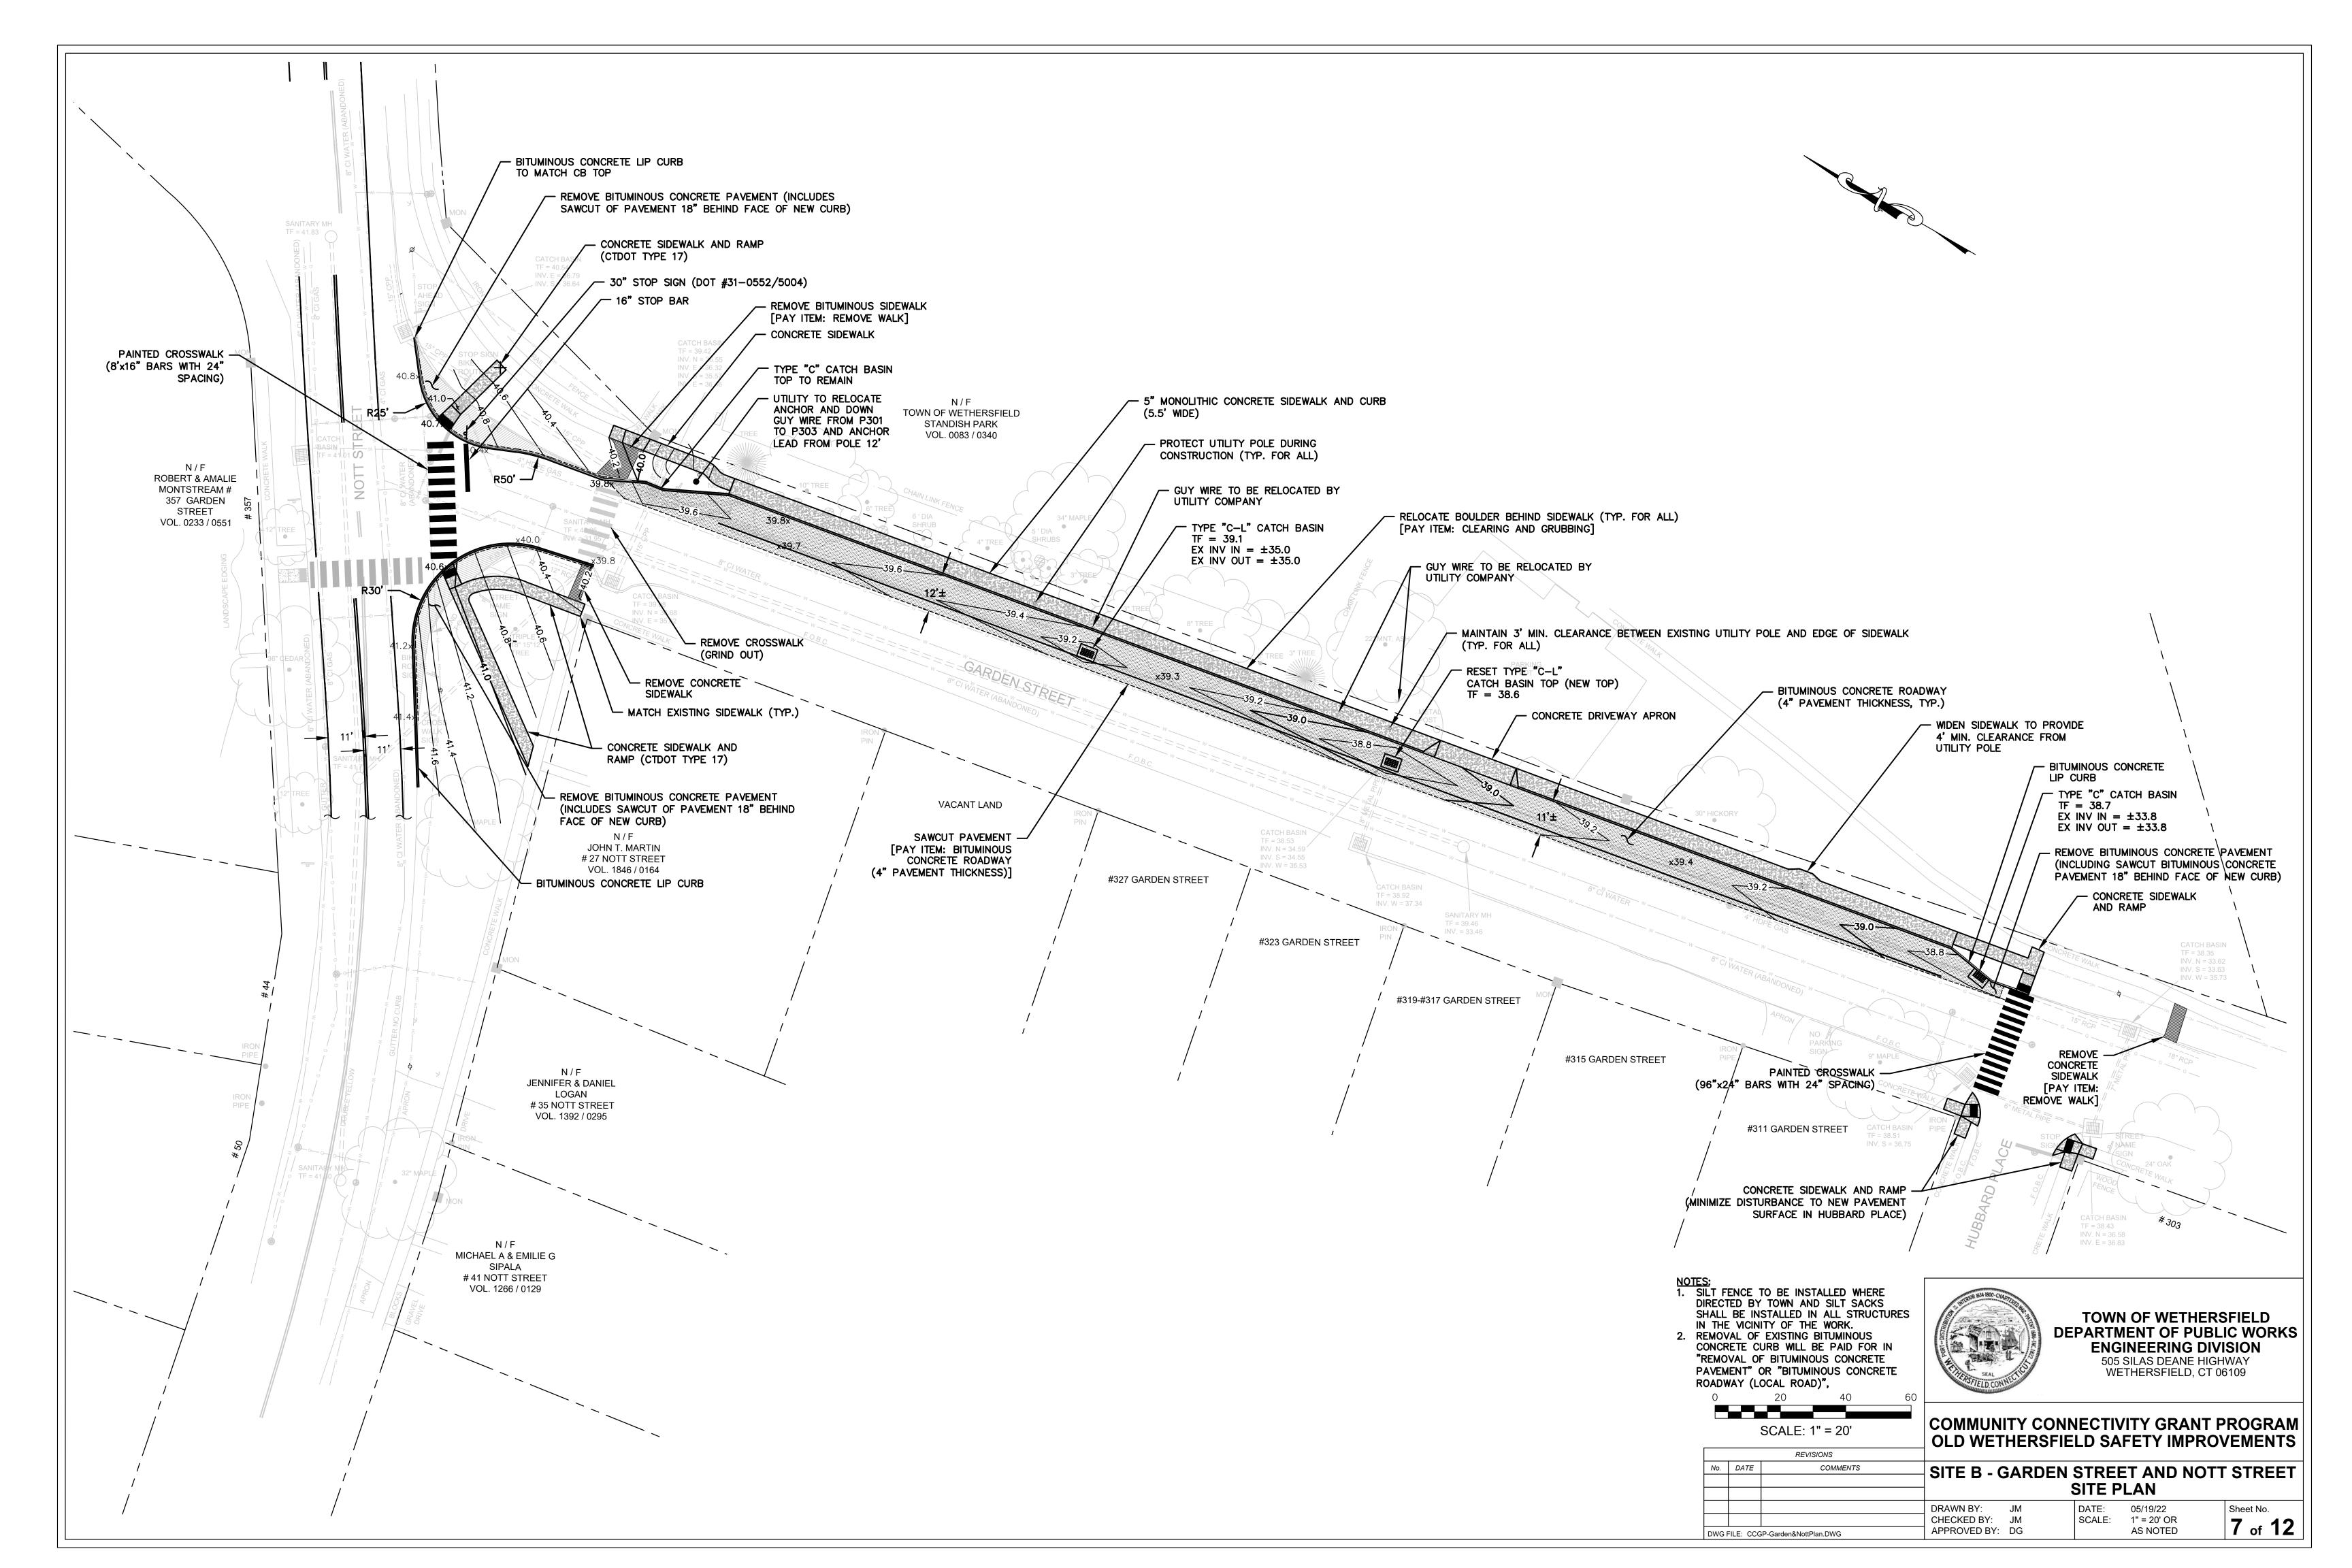

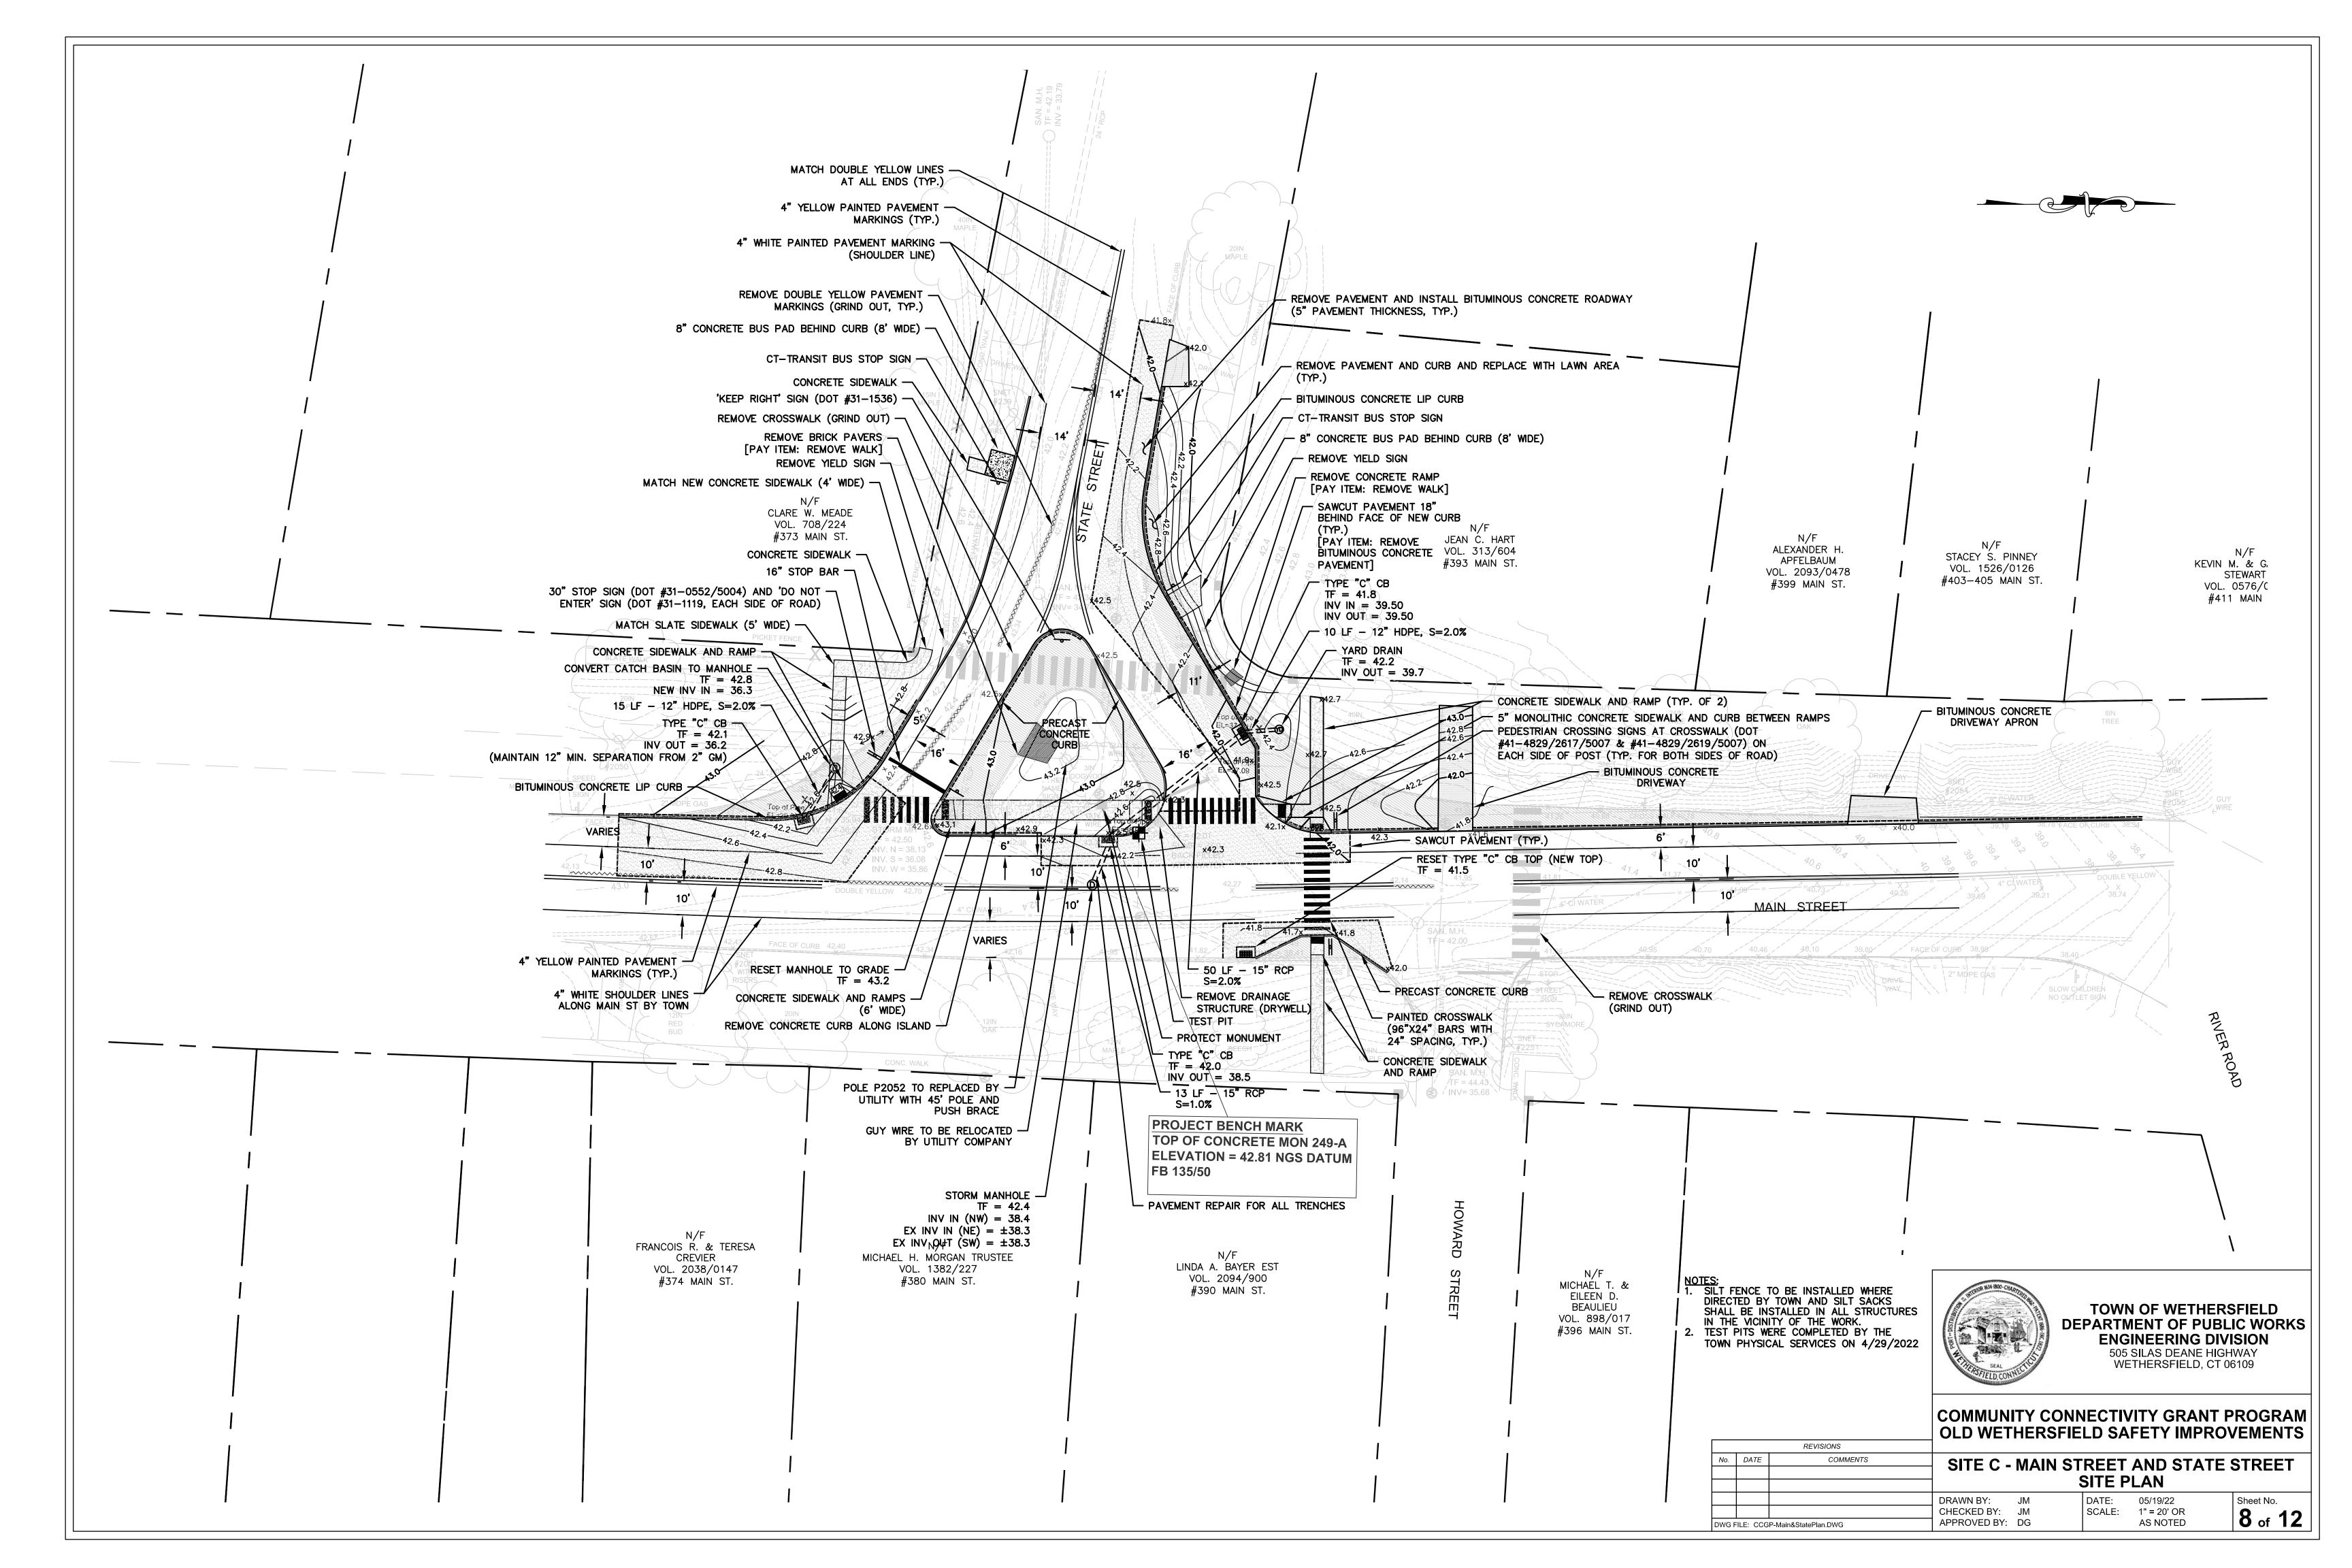

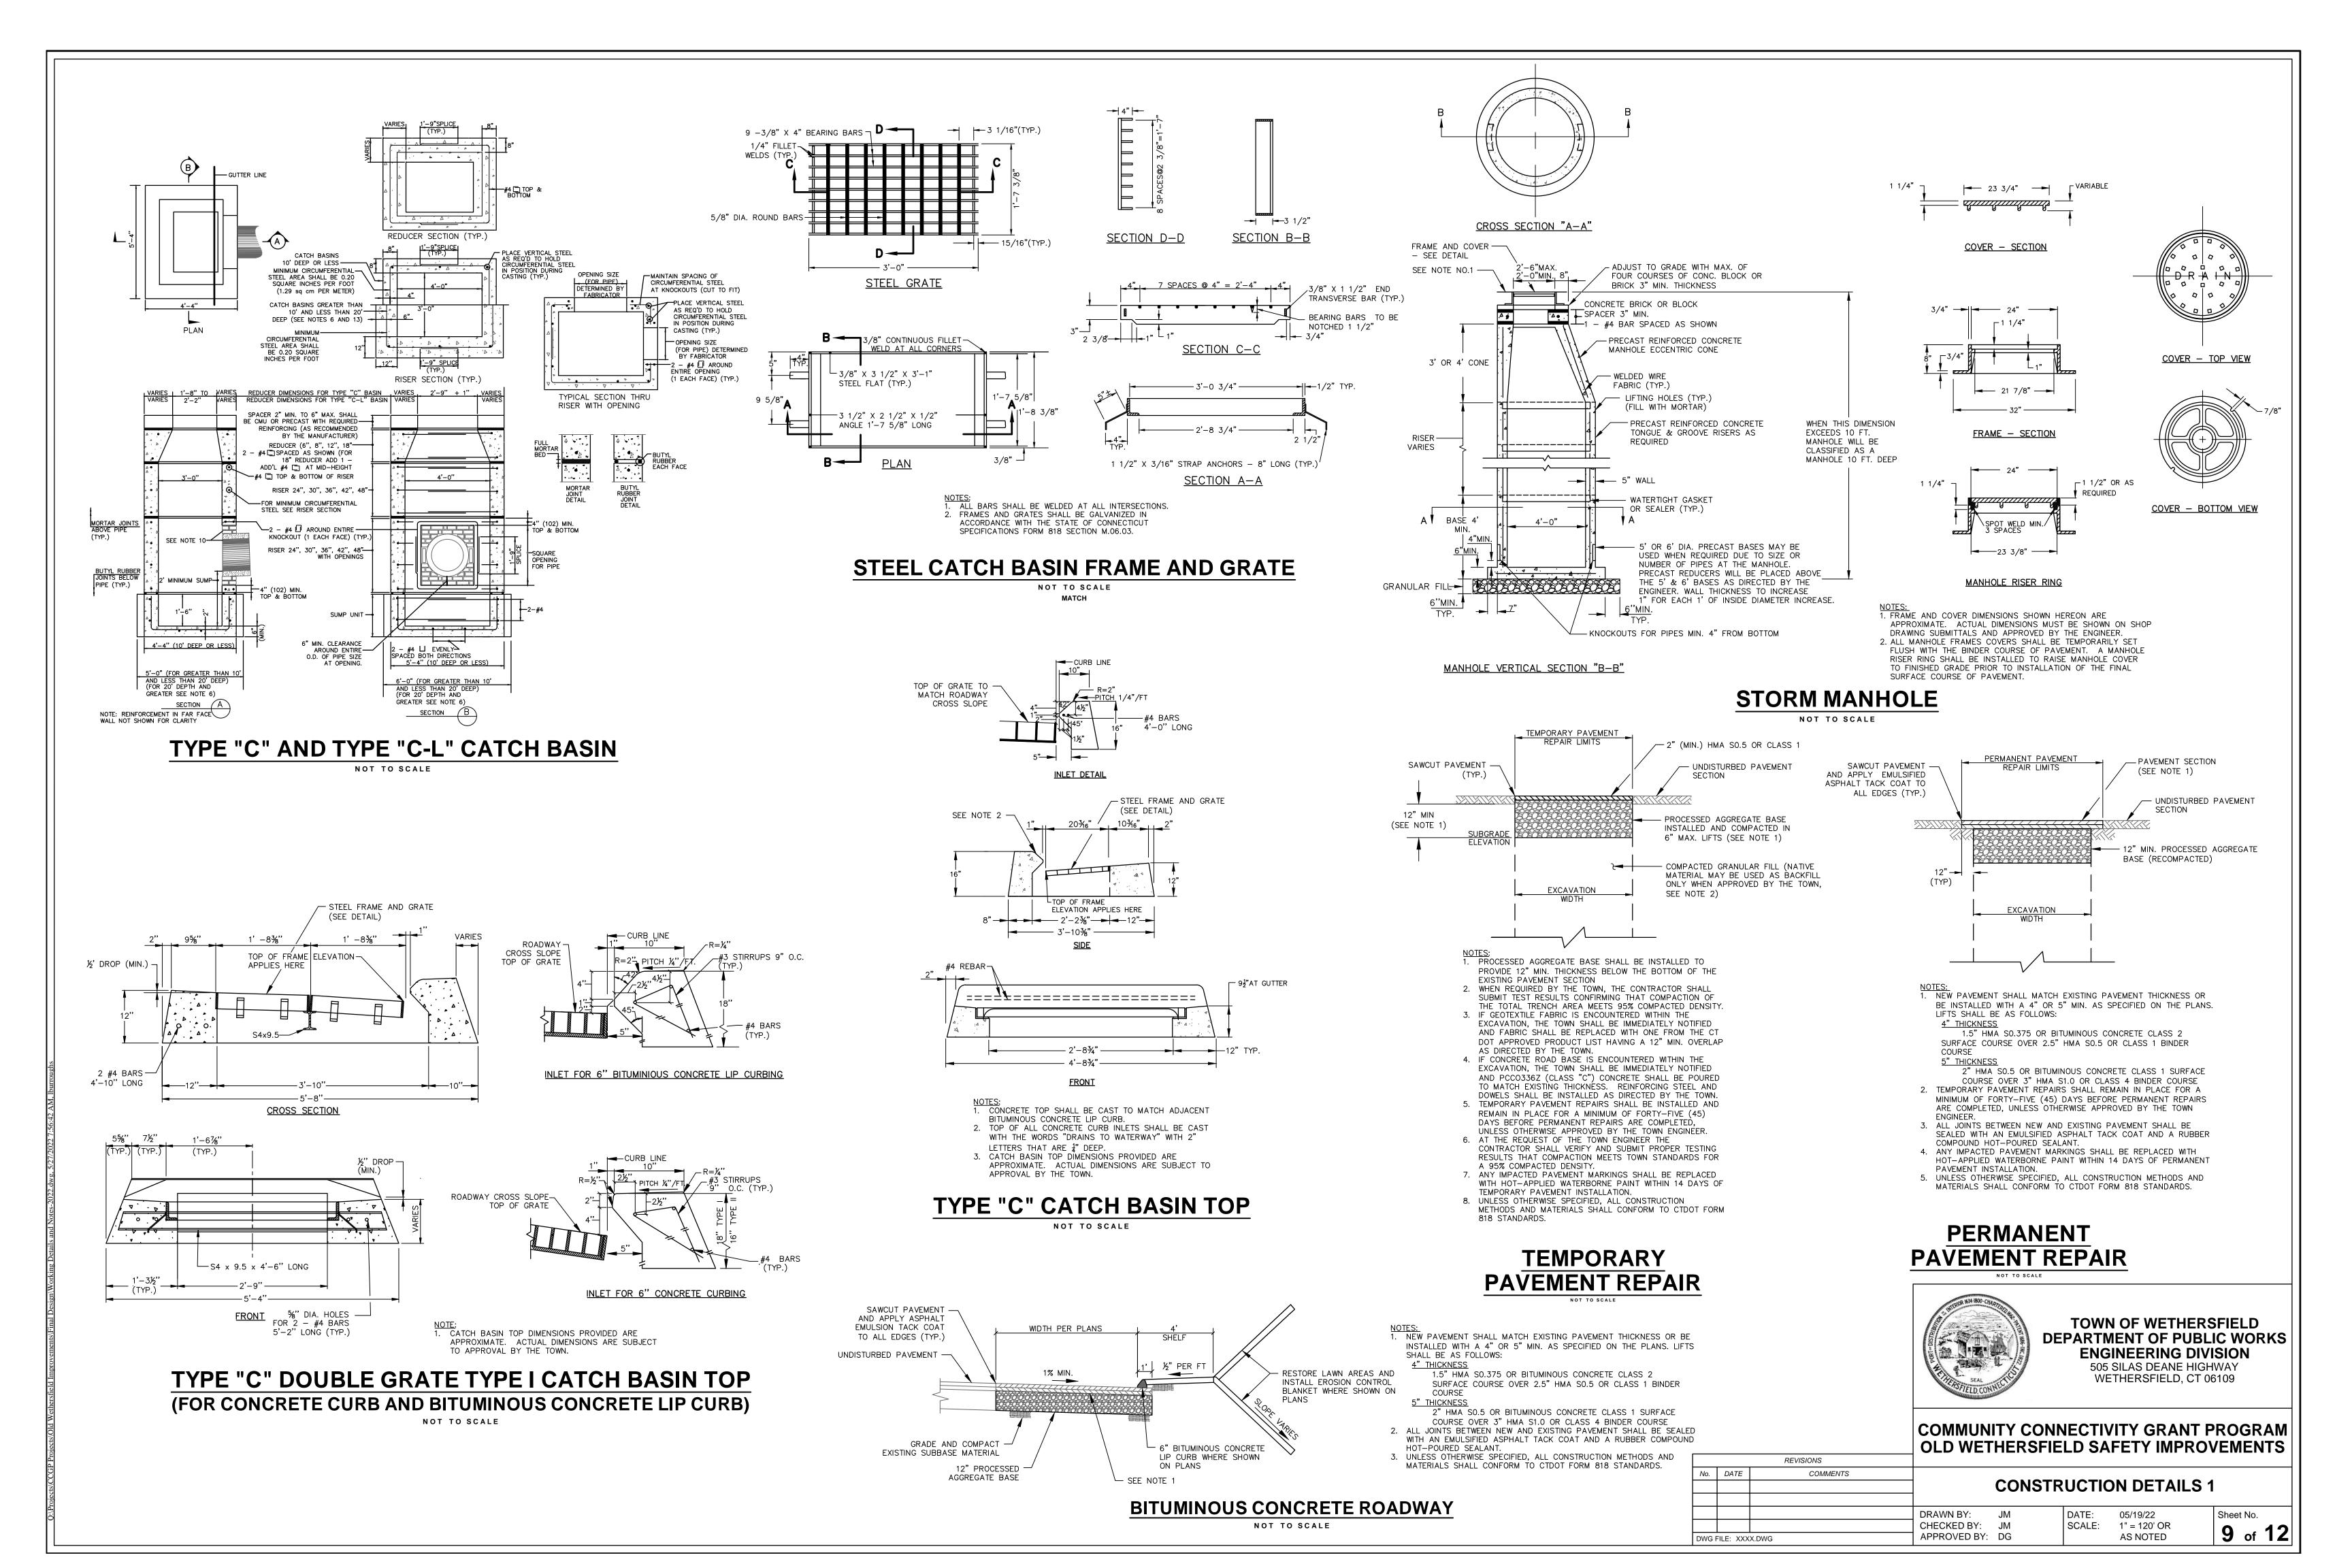

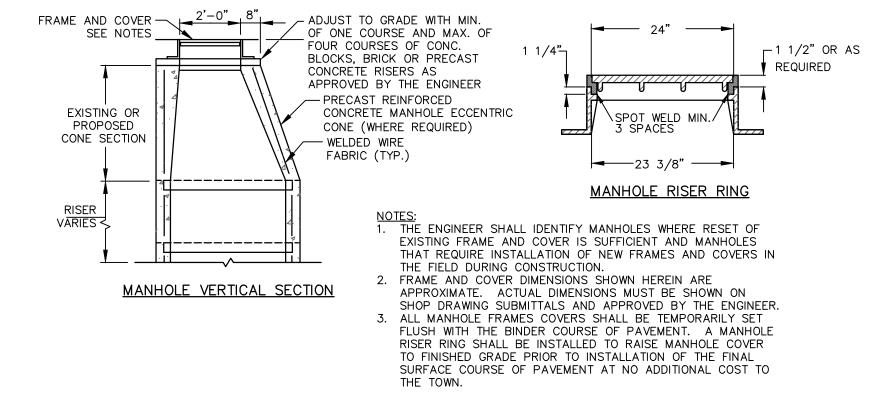

RESET MANHOLE TO GRADE

CATCH BASIN NOTES:

- REINFORCEMENT SHALL CONFORM TO ASTM A615, GRADE 60.
 CATCH BASIN DETAILS SHOW STANDARD REINFORCEMENT. WELDED WIRE FABRIC WITH AN AREA EQUAL TO OR GREATER THAN THE REINFORCING SHOWN MAY BE
- SUBSTITUTED.

 3. ALL LAP SPLICES, DEVELOPMENT LENGTHS, BENDS FOR REINFORCEMENT, AND WELDED WIRE FABRIC SHALL CONFORM TO AASHTO STANDARD SPECIFICATIONS FOR
- 4. ALL REINFORCEMENT SHALL HAVE A MINIMUM CLEAR COVER OF 2".

 5. MINIMUM CONCRETE COMPRESSIVE STRENGTH Fc' = 4000 PSI SHALL BE OBTAINED
- PRIOR TO SHIPPING.

 6. BASES AND RISERS AT A DEPTH OF 20' OR MORE SHALL BE DESIGNED BY THE CONTRACTOR AND WORKING DRAWINGS SHALL BE SUBMITTED TO THE TOWN FOR
- REVIEW.

 7. SEE APPROPRIATE DETAIL FOR CATCH BASIN FRAMES AND GRATES.

 8. RISERS MAY BE PREFABRICATED WITH PIPE OPENINGS IN ALL FOUR WALLS.

 ADEQUATE REINFORCING AROUND PIPE OPENINGS CONFORMING TO THESE PLANS
- SHALL BE PROVIDED. ANY RISERS USED WHERE A PIPE OPENING IS TO REMAIN IN PLACE, MUST BE FORMED UP WITH BRICK AS DIRECTED BY THE TOWN.

 9. RISERS SHALL NEVER HAVE CORNER PIPE ENTRIES.


 10. ALL OPENINGS SURROUNDING PIPES SHALL BE CLOSED USING CEMENT RUBBLE MASONRY CONFORMING TO THE LATEST STATE OF CONNECTICUT STANDARD
- MASONRY CONFORMING TO THE LATEST STATE OF CONNECTICUT STANDARD SPECIFICATIONS MATERIAL SECTION M6.06. IF THE TOWN DETERMINES THAT THE CLOSURE OF ANY PIPE OPENING IS UNSATISFACTORY, THE CONTRACTOR SHALL IMMEDIATELY RECLOSE SAID OPENING. THE LOCATION OF PIPE OPENINGS SHALL NOT REDUCE THE WALL THICKNESS.
- 11. THE LATEST CONNECTICUT D.O.T. STANDARD SPECIFICATIONS AND SUPPLEMENTALS SHALL GOVERN.
 12. WALL THICKNESS OF ALL CATCH BASINS OVER 10' DEEP SHALL BE INCREASED TO 12" THICK. INSIDE DIMENSION SHALL REMAIN THE SAME (THE 12" THICKNESS WILL
- START AFTER THE FIRST 10').

 13. BUTYL RUBBER JOINT SEAL SHALL CONFORM TO AASHTO M-198 AND MORTAR SHALL CONFORM TO THE LATEST STATE OF CONNECTICUT STANDARD
- SPECIFICATIONS MATERIAL SECTION M11.04. ALL CATCH BASINS SHALL BE BUILT WITH SPACERS AS SHOWN IN THE DETAILS.

 14. SHRINKAGE AND TEMPERATURE REINFORCEMENT SHALL BE PROVIDED IN THE TOPS
- OF SLABS. THE TOTAL AREA OF REINFORCEMENT PROVIDED SHALL BE AT LEAST 0.125 SQUARE INCHES PER FOOT IN EACH DIRECTION. THE MAXIMUM SPACING OF THIS REINFORCEMENT SHALL NOT EXCEED 18 INCHES.

 15. ALL CONCRETE CATCH BASIN TOPS SHALL BE CAST TO MATCH ADJACENT CURB
- TYPE AND HEIGHT.

 16. CATCH BASIN TOP DIMENSIONS PROVIDED ON THE PLANS ARE APPROXIMATE.
- ACTUAL DIMENSIONS ARE SUBJECT TO APPROVAL BY THE TOWN.

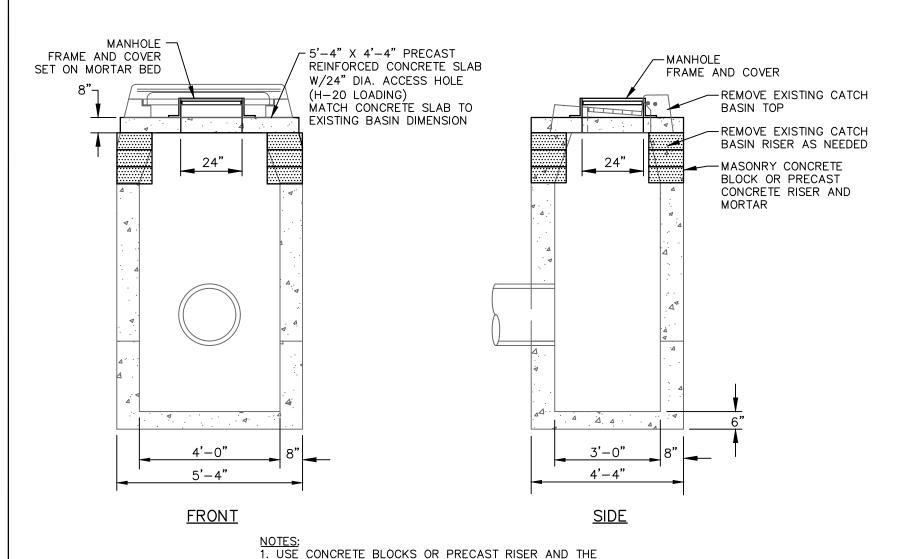

ALSO APPLIES TO TYPE "C-L" CATCH BASIN TOPS. CONVERT CATCH BASIN TO MANHOLE

NOT TO SCALE

CONCRETE SLAB TO BRING THE MANHOLE COVER TO GRADE.

2. TYPE "C" CATCH BASIN TOP IS SHOWN; HOWEVER, DETAIL

DECORATIVE LIGHT FOUNDATION NOT TO SCALE

ELEVATION VIEW

PLAN VIEW

GENERAL NOTES:

- 1. FIELD SURVEY WAS PERFORMED BY TOWN OF WETHERSFIELD DEPARTMENT OF PUBLIC WORKS, DIVISION OF ENGINEERING. COORDINATES ARE BASED ON HORIZONTAL DATUM NAD 1983 AND VERTICAL DATUM OF NAVD 1988.
- 2. CONTRACTOR TO COORDINATE WIT CONNECTICUT NATURAL GAS TO ADJUST GATE VALVESCOVERS AS NEEDED.
- SILT SACKS TO BE INSTALLED DOWNSTREAM OF CONSTRUCTION AND AS DIRECTED BY ENGINEER.
 REFER TO CONNECTICUT DEPARTMENT OF TRANSPORTATION SIGN CATALOG FOR ADDITIONAL INFORMATION REGARDING PROPOSED SIGNS AND DETAIL SHEET TR_1208_02 FOR MOUNTING AND POSTS DETAILS.
- 5. UTILITY LOCATIONS SHOWN ARE FROM RECORD DATA AND ARE NOT GUARANTEED TO BE ACCURATE. THE CONTRACTOR IS REQUIRED TO "CALL BEFORE YOU DIG", 1-800-922-4455, AND HAVE ALL UNDERGROUND UTILITIES PHYSICALLY MARKED ON THE GROUND IN THE AREA OF CONSTRUCTION.
- 6. ALL MATERIALS AND METHODS OF CONSTRUCTION SHALL BE IN ACCORDANCE WITH CONTRACT SPECIFICATIONS. FOR IMPROVEMENTS NOT SPECIFICALLY STATED ON THE CONTRACT PLANS OR IN THE SPECIFICATIONS, WORK SHALL MEET THE STATE OF CONNECTICUT, DEPARTMENT OF TRANSPORTATION, STANDARD SPECIFICATIONS FOR ROADS, BRIDGES, FACILITIES AND INCIDENTAL CONSTRUCTION, FORM 817 (AS AMENDED).
- 7. CONTRACTOR IS MADE AWARE THAT THE TOWN RESERVES THE RIGHT TO CHANGE THE SCOPE OF THE PROJECT FOR ANY REASON BEFORE OR AFTER THE BID IS AWARDED, AND MAY REDUCE ANY OR ALL QUANTITIES FOR ITEMS SHOWN ON THE BID FORM OR ELIMINATE ITEMS OF WORK ENTIRELY AS REQUIRED TO ACCOMMODATE AVAILABLE FUNDING LIMITS.
- 8. REFER TO THE TECHNICAL SPECIFICATIONS FOR ADDITIONAL INFORMATION REGARDING MATERIALS AND INSTALLATION REQUIREMENTS.
- 9. IMPLEMENTATION OF WORKER SAFETY AND HEALTH PROTOCOLS THAT ADDRESS COMPLIANCE WITH ALL RULES, LAWS AND REGULATIONS REGARDING SAFETY AND RISK OF EXPOSURE TO PHYSICAL AND CHEMICAL HAZARDS IS THE SOLE RESPONSIBILITY OF THE CONTRACTOR. ALL EMPLOYEES OF THE CONTRACTOR AND SUBCONTRACTORS ARE REQUIRED TO WEAR REFLECTIVE VESTS AND HARD HATS AT ALL TIMES WHEN ON THE PROJECT SITE.
- 10. A PRE—CONSTRUCTION MEETING WITH TOWN STAFF IS REQUIRED PRIOR TO THE START OF ANY CONSTRUCTION ACTIVITY.
- 11. THE CONTRACTOR SHALL PHASE CONSTRUCTION OPERATIONS TO MINIMIZE THE SIZE OF DISTURBED AREAS AND PERIOD OF TIME THESE AREAS ARE LEFT UNSTABILIZED AND SUBJECT TO FROSION
- 12. THE CONTRACTOR SHALL COMMIT SUFFICIENT RESOURCES TO THE PROJECT TO ENSURE THE PROJECT IS COMPLETED WITHIN THE ALLOTTED CONTRACT TIME. ONCE MOBILIZED, THE CONTRACTOR SHALL WORK CONTINUOUSLY ON THE PROJECT UNTIL COMPLETION. ANY UNAUTHORIZED VACATING OF THE JOBSITE FOR MORE THAN TEN (10) CONSECUTIVE CALENDAR DAYS IS SUBJECT TO PENALTIES DESCRIBE UNDER THE "LIQUIDATED DAMAGES" SECTION OF THE CONTRACT SPECIFICATIONS.
- 13. THE CONTRACTOR SHALL PROVIDE TEMPORARY ACCESS TO THE FACILITY AT ALL TIMES
- 14. EXCAVATIONS CANNOT BE LEFT OPEN IN THE PUBLIC RIGHT-OF-WAY FOR MORE THAN 48-HOURS.
- 15. AT A MINIMUM, THE CONTRACTOR SHALL PAVE TRENCHES AND OTHER EXCAVATIONS IN THE ROAD AT THE END OF EACH WORK WEEK.
- 16. CONTRACTOR SHALL SECURE EQUIPMENT AND LEAVE SITE IN SAFE MANNER AT THE END OF EACH DAY.
- 17. SEDIMENT CONTROL SYSTEMS SHALL BE INSTALLED IF DIRECTED BY THE TOWN AND MEET THE "GUIDELINES FOR SOIL EROSION AND SEDIMENT CONTROL" AS PREPARED BY THE CONNECTICUT COUNCIL ON SOIL AND WATER CONSERVATION, LATEST REVISION. THE CONTRACTOR IS RESPONSIBLE FOR THE INSTALLATION, MAINTENANCE AND REPAIR OF EROSION CONTROLS REQUIRED FOR THE PROJECT. ADDITIONAL EROSION CONTROLS SHALL BE INSTALLED BY THE CONTRACTOR FOR TEMPORARY STOCKPILING OF EXCAVATED MATERIAL AND WHERE DEEMED NECESSARY BY THE ENGINEER. EROSION CONTROLS SHALL REMAIN IN PLACE AND MAINTAINED BY THE CONTRACTOR UNTIL THE SITE IS STABILIZED AND THE ENGINEER APPROVES THEIR REMOVAL.
- 18. HORIZONTAL AND VERTICAL LOCATIONS OF PROPOSED WORK MAY BE ADJUSTED TO FIT EXISTING FIELD CONDITIONS WITH THE APPROVAL OF THE ENGINEER.
- 19. THE CONTRACTOR SHALL IMMEDIATELY NOTIFY THE ENGINEER IF CONDITIONS ENCOUNTERED IN THE FIELD ARE DIFFERENT THAN INFORMATION SHOWN ON THE PLANS.
- 20. THE CONTRACTOR MUST DISPOSE OF SURPLUS EXCAVATED MATERIAL OFFSITE
- 21. RECORD DRAWINGS WITH MARK-UPS OF ALL NEW CONSTRUCTION RELATED TO THE PROJECT SHALL BE SUBMITTED TO THE TOWN UPON COMPLETION OF WORK. THE CONTRACTOR SHALL BE RESPONSIBLE FOR PROCURING ALL INFORMATION NECESSARY FOR THE TOWN TO GENERATE FINAL AS-BUILT DRAWINGS. A REDLINED PROGRESS SET OF DRAWINGS SHALL BE MAINTAINED DAILY AND BE AVAILABLE TO THE ENGINEER AT ALL TIMES.
- 22. THE CONTRACTOR SHALL COORDINATE WITH CT NATURAL GAS TO HAVE THEIR CREWS ADJUST GATE VALVE COVERS ON THE GAS SYSTEM AS REQUIRED.
- 23. SILT SACKS SHALL BE INSTALLED IN CATCH BASINS BELOW AREAS OF CURB REMOVAL AND WHERE DIRECTED BY THE ENGINEER.
- 24. REFER TO CTDOT SIGN CATALOG REVISED 7/13/19 FOR ADDITIONAL INFORMATION REGARDING PROPOSED SIGNS AND DETAIL SHEET TR_1208-02 FOR MOUNTING AND POST INFORMATION.

' DIA. BOLT CIRCLE OR DIRECTED BY ENGINEER

- 4½" DIA. ANCHOR BOLTS

FINISHED GRADE

EXPANSION MATERIAL

- CLASS 'F' CONCRETE

2" PVC CONDUIT

- GROUND ROD

(NUMBER OF CONDUITS

DETERMINED FROM PLAN,
PROVIDE TWO CONDUITS MIN.)

- #3 REINFORCING HOOPS

4 - #6 REBARS, 84" LONG

(4,000 PSI)


1" BEVEL

SEE APPROPRIATE SURFACE FINISHED GRADE -RESTORATION DETAIL **.\\.\\. **VARIES** GRANULAR FILL OR SUITABLE NATIVE MATERIAL APPROVED BY THE TOWN THAT IS PLACED AND COMPACTED IN 12" MAX. LIFTS (SEE NOTE 4) ___ 0.25 O.D. - BEDDING MATERIAL (SEE NOTES 3 AND 4) GRANULAR FILL WHEN 4" IN EARTH -UNSUITABLE MATERIAL IS 12" MIN. IN ROCK ENCOUNTERED (DEPTH AS DIRECTED BY TOWN) I.D.+2' FOR PIPE UNDER 30", I.D.+3' FOR PIPE 30" AND LARGER

STORM SEWER TRENCH


- NOTES: NOT TO SCALE

 1. ALL CONCRETE PIPE TO BE MINIMUM CLASS IV WITH 2 FT OF COVER UNLESS OTHERWISE APPROVED BY THE ENGINEER.
- USE WATERTIGHT RUBBER GASKETS IN ALL PIPE JOINTS.
 BEDDING MATERIAL SHALL BE INSTALLED A MINIMUM OF 12" ABOVE THE TOP OF ALL PLASTIC PIPES AND PIPES 48" IN DIAMETER AND LARGER
- 4. PIPE BEDDING SHALL BE SAND OR SANDY SOIL, ALL OF WHICH PASSES §" SIEVE AND < 10% PASSING 200 SIEVE THAT IS PLACED AND COMPACTED IN 6" LIFTS. NO STONE SHALL BE LARGER THAN 1-1/2" AND MATERIAL SHALL MEET CT DOT M2.05.
- 5. WHEN GROUND WATER IS ENCCOUNTERED, $\frac{3}{4}$ " STONE SHALL SUBSTITUTED FOR PIPE BEDDING, AND BACKFILLED TO 12" ABOVE THE TOP OF THE
- 6. WHEN REQUIRED BY THE TOWN, THE CONTRACTOR SHALL SUBMIT TEST RESULTS CONFIRMING THAT COMPACTION OF THE TOTAL TRENCH AREA MEETS 95% COMPACTED DENSITY
- ALL CONSTRUCTION METHODS AND MATERIALS SHALL CONFORM TO CTDOT FORM 818 STANDARDS.

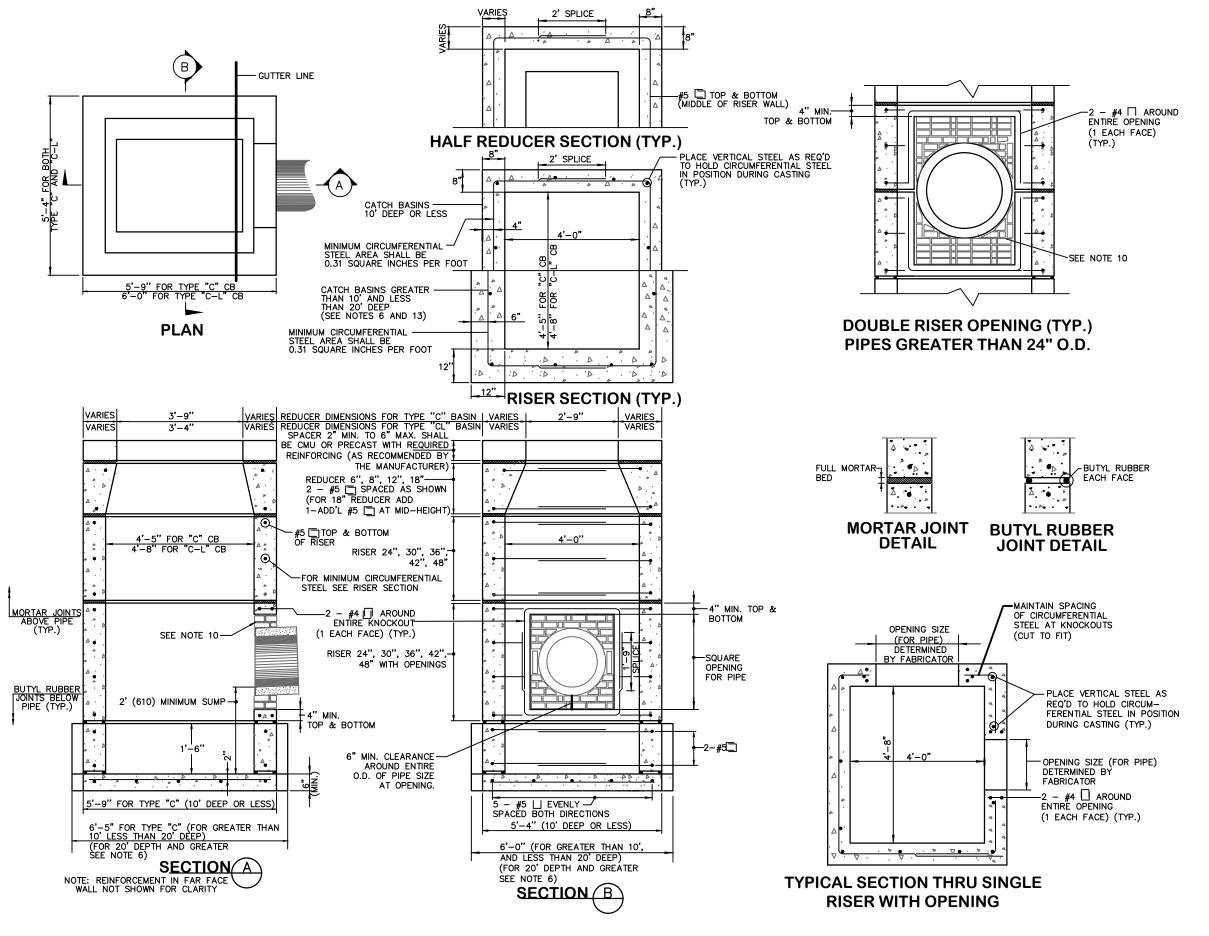

TYPE "C" AND TYPE "C-L" DOUBLE GRATE TYPE I CATCH BASIN

(STRUCTURE UNDER 10' DEEP SHOWN)

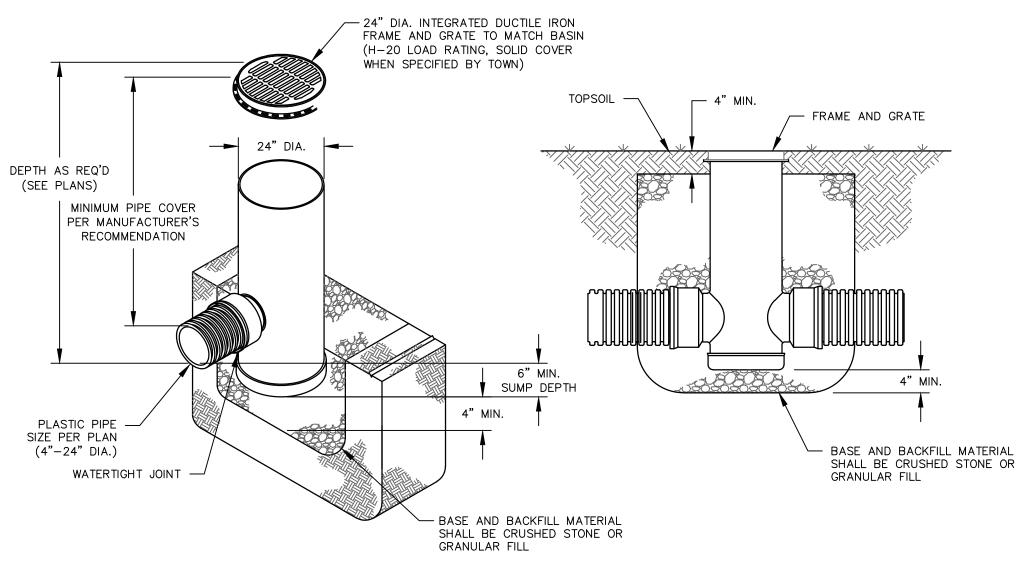



YARD DRAIN NOT TO SCALE




TOWN OF WETHERSFIELD
DEPARTMENT OF PUBLIC WORKS
ENGINEERING DIVISION
505 SILAS DEANE HIGHWAY
WETHERSFIELD, CT 06109

COMMUNITY CONNECTIVITY GRANT PROGRAM OLD WETHERSFIELD SAFETY IMPROVEMENTS

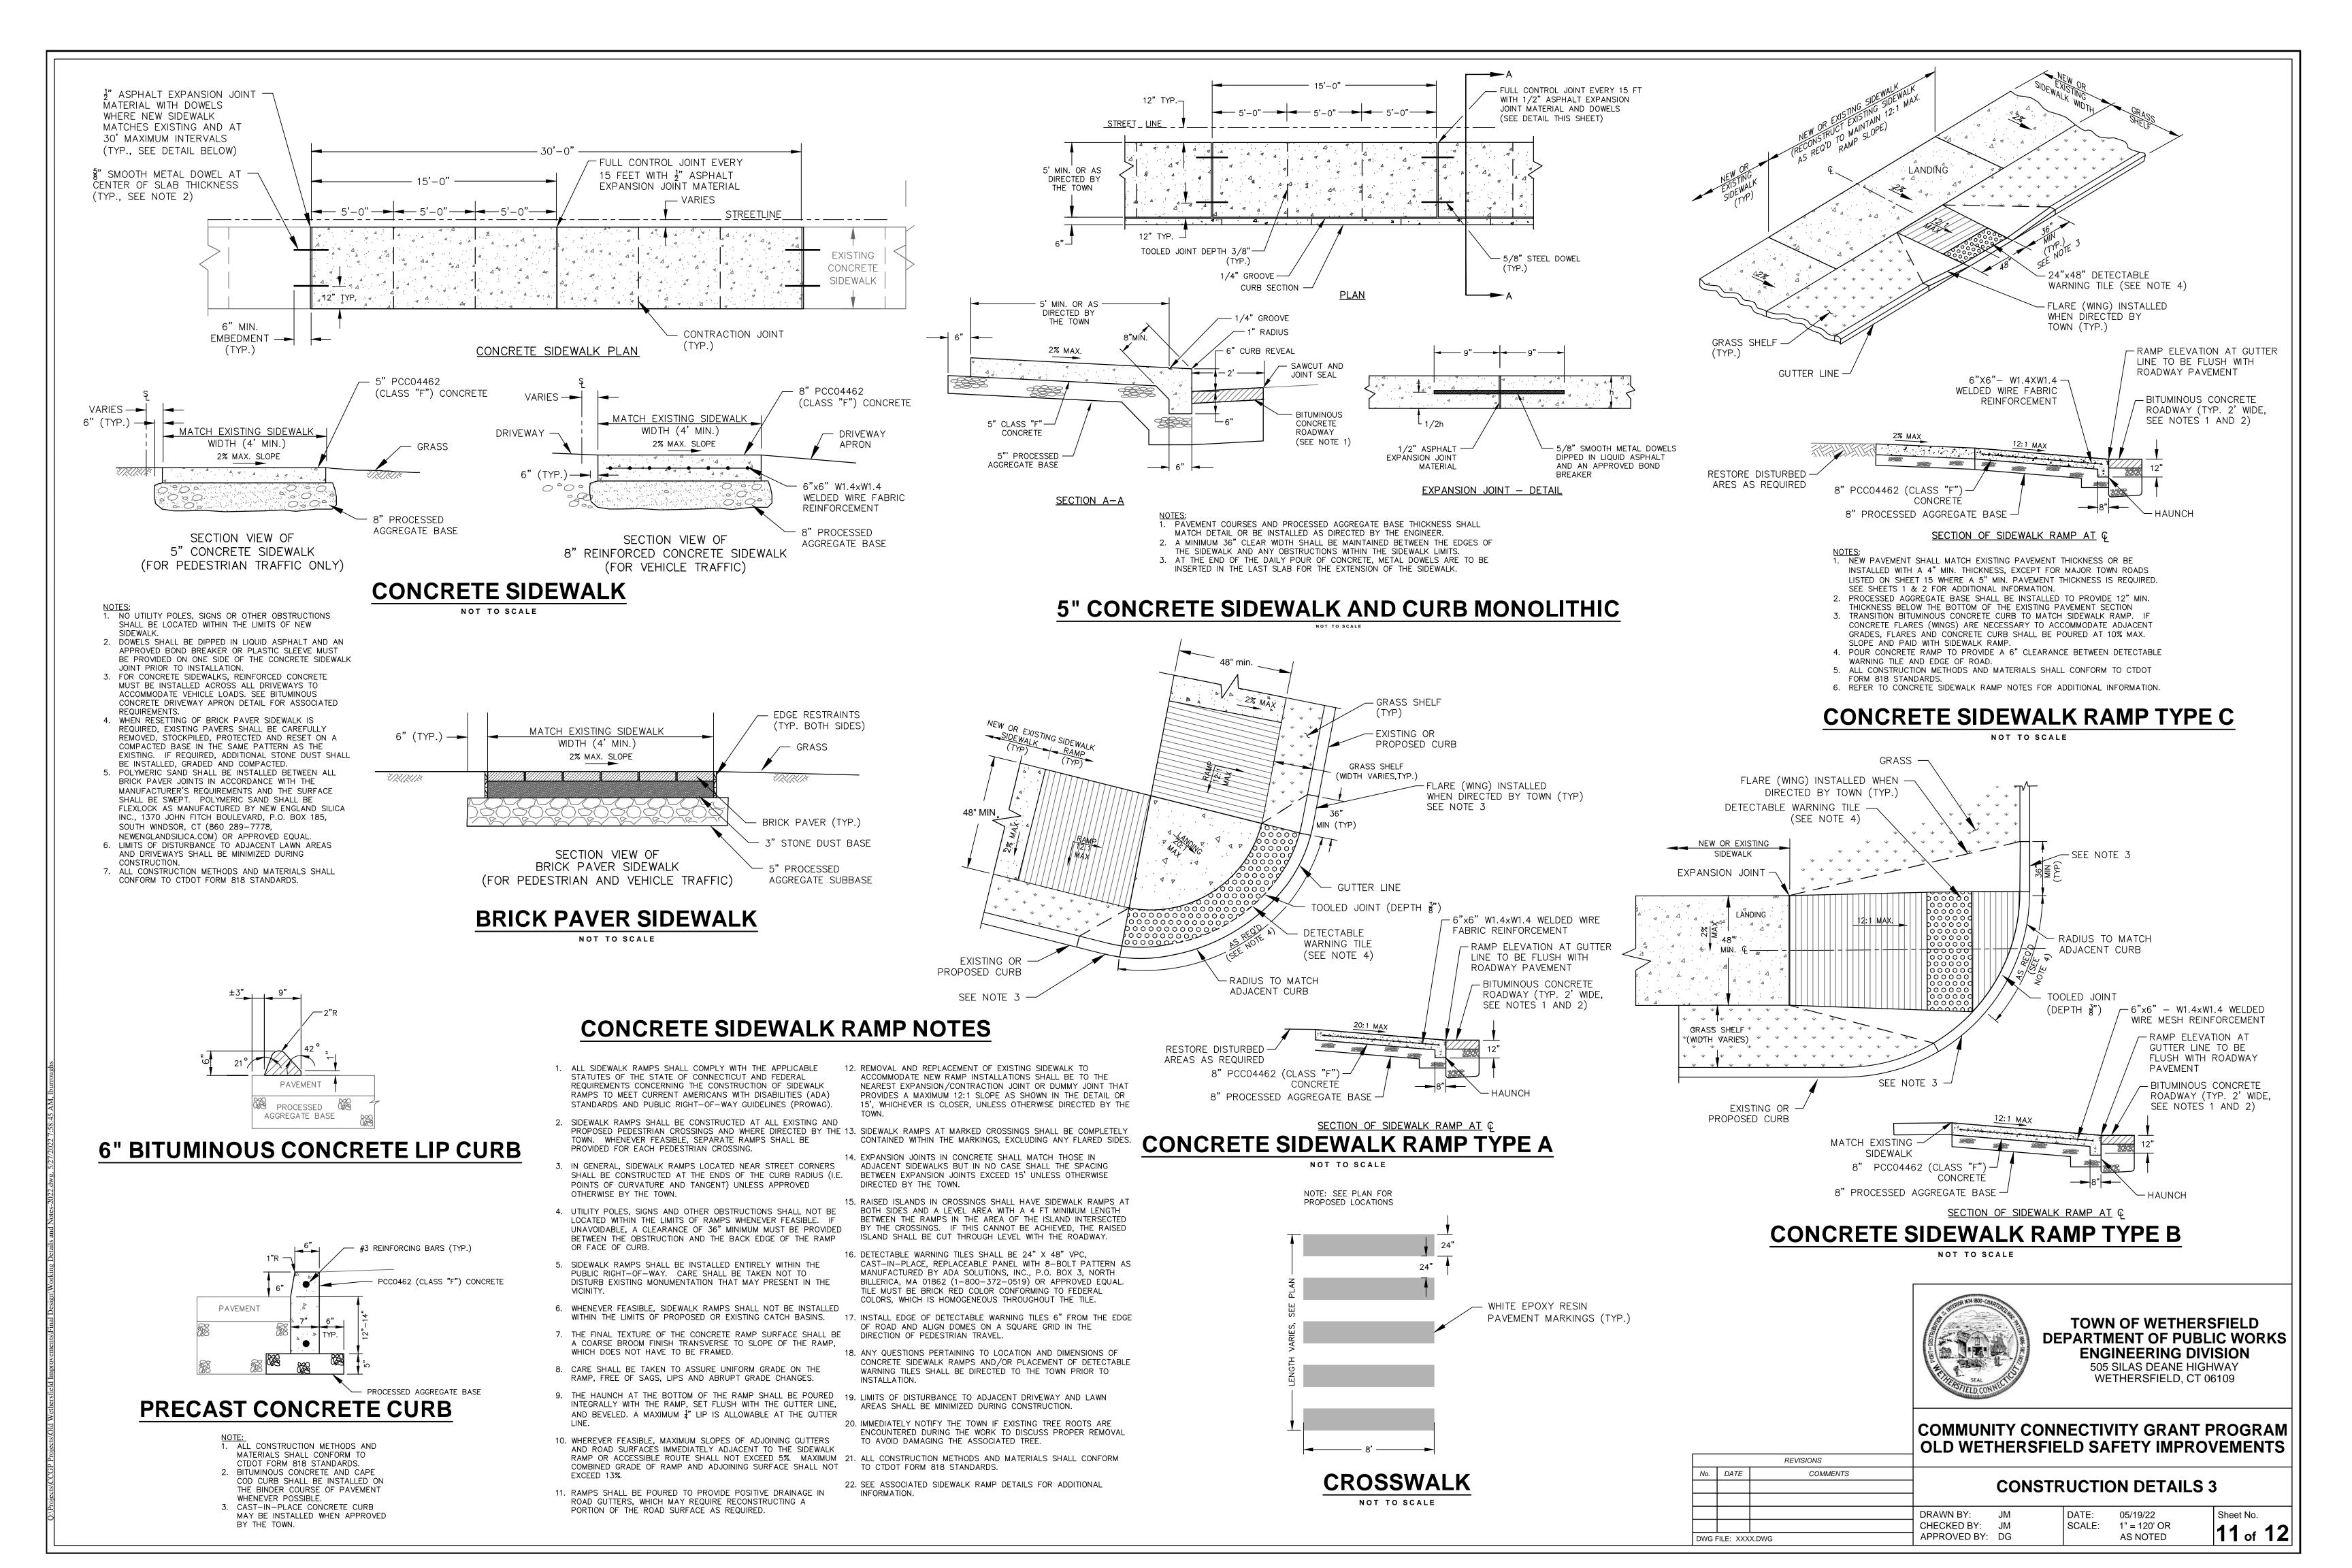

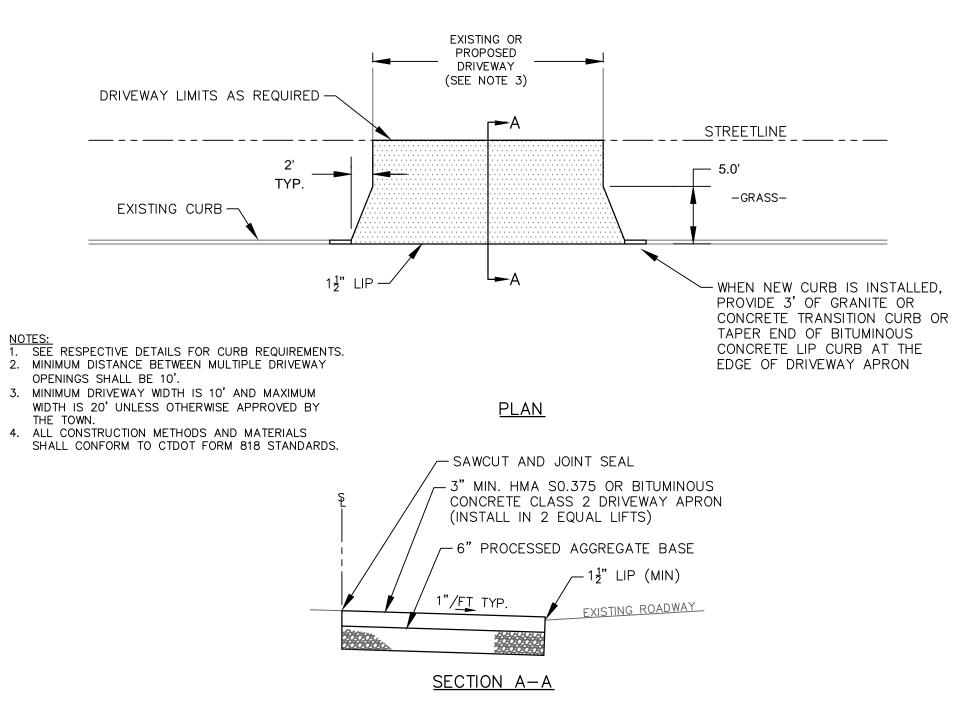


BITUMINOUS CONCRETE DRIVEWAY APRON

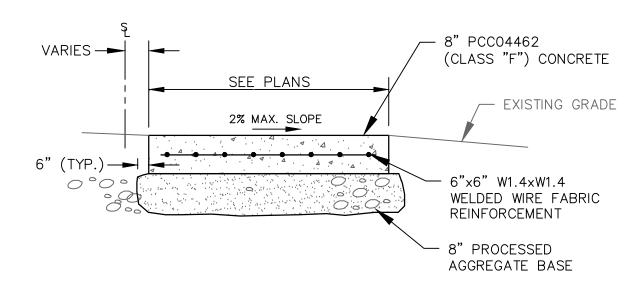

SECTION VIEW OF 8" REINFORCED CONCRETE BUS PAD

CONCRETE BUS PAD

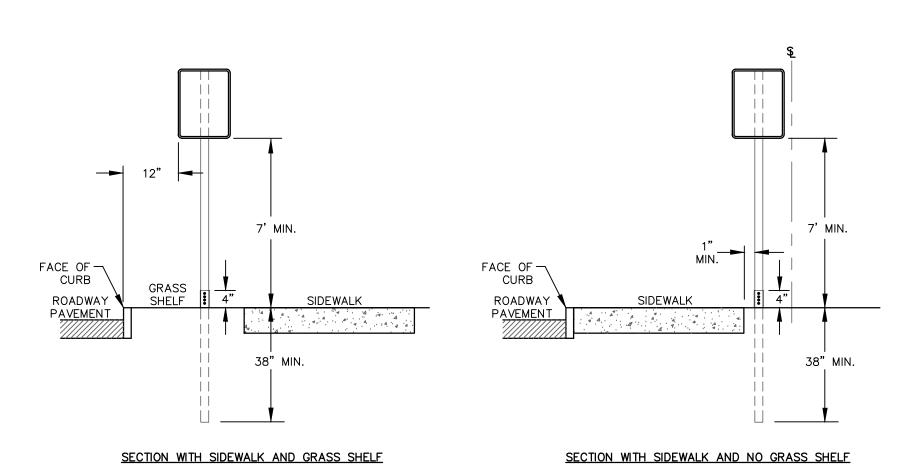


NOTES:

1. SUPPORTS SHALL BE METAL GALVANIZED STEEL POSTS WITH BREAKAWAY COUPLING SYSTEM.

2. WHERE POSTS CANNOT BE INSTALLED BEHIND SIDEWALK, THEY SHALL BE INSTALLED WITH THE EDGE OF THE SIGN 12" FROM FACE OF CURB.

SIGN INSTALLATION - TYPICAL

NOT TO SCALE

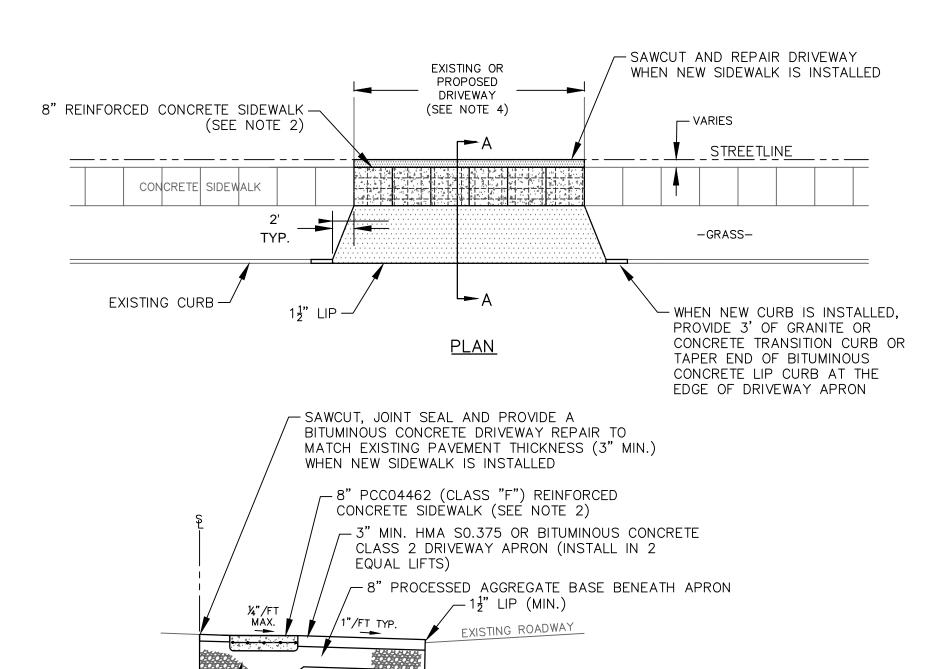

NOTES: 1. SEE RESPECTIVE DETAILS FOR CONCRETE SIDEWALK


- AND CURB REQUIREMENTS.


 2. REINFORCED CONCRETE SIDEWALK IS REQUIRED ACROSS DRIVEWAY WIDTH TO ACCOMMODATE VEHICLE LOADS. REFER TO ASSOCIATED DETAIL FOR ADDITIONAL INFORMATION.
- 3. MINIMUM DISTANCE BETWEEN MULTIPLE DRIVEWAY OPENINGS SHALL BE 10'.
- 4. MINIMUM DRIVEWAY WIDTH IS 10' AND MAXIMUM WIDTH IS 20' UNLESS OTHERWISE APPROVED BY
- 5. ALL CONSTRUCTION METHODS AND MATERIALS SHALL CONFORM TO CTDOT FORM 818 STANDARDS.

BITUMINOUS CONCRETE DRIVEWAY APRON(WITH SIDEWALK


SECTION A-A

SEE CONCRETE SIDEWALK — DETAIL FOR SECTION

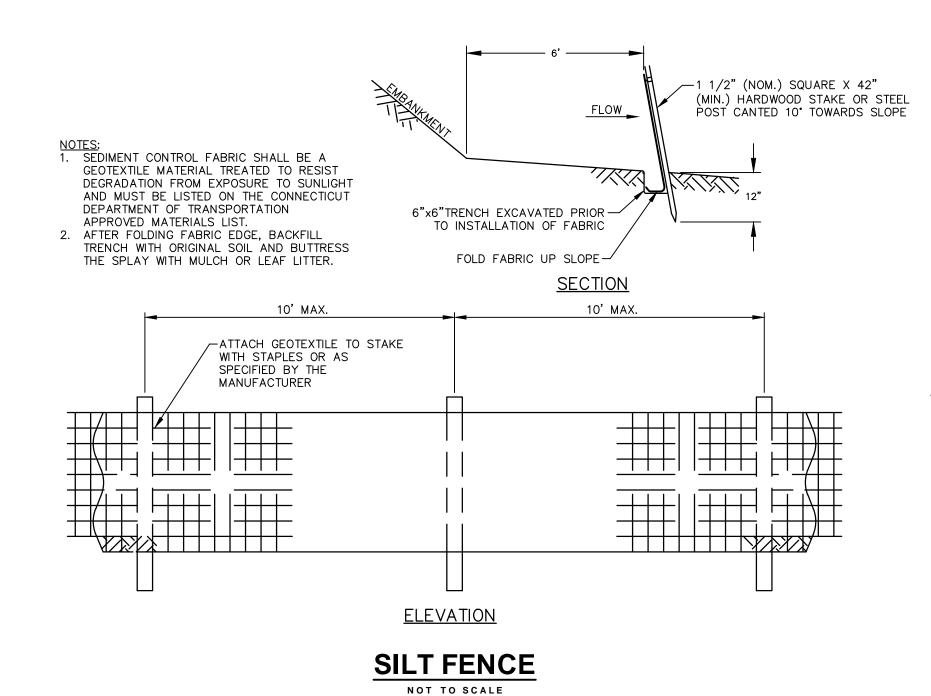

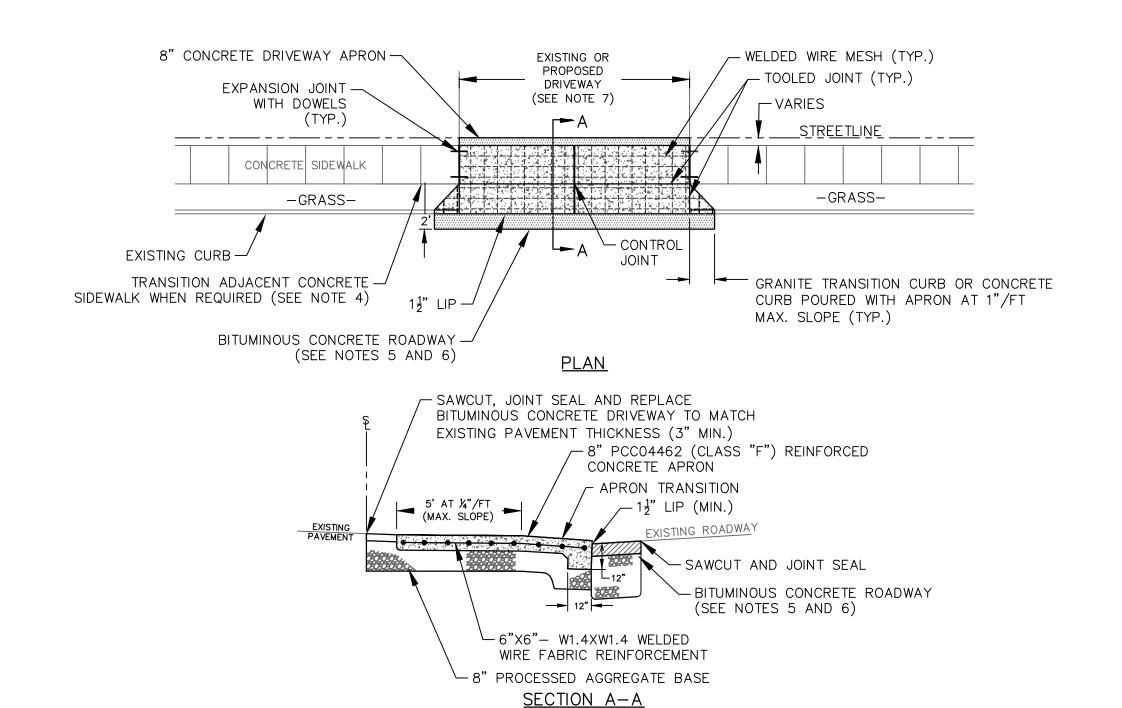

CONCRETE DRIVEWAY APRON

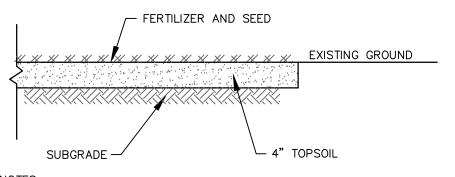


NOTES:

1. PERMANENT GRASS SEED MIX SHALL BE APPLIED FROM APRIL 1
THOUGH JUNE 15 OR AUGUST 15 THROUGH OCTOBER 1 AND SHALL
MEET SECTION M.13.04 IN CTDOT FORM 818 AS FOLLOWS:

Proportion by Weight (Mass) (Pounds)	Minimum Purity (Percent)	Minimum Germination (Percent)
25	96	85
35	97	80
10	95	90
15	95	90
5	95	90
10	95	90
	Weight (Mass) (Pounds) 25 35 10 15	Weight (Mass) (Pounds) Purity (Percent) 25 96 35 97 10 95 15 95 5 95

- UNDER NO CIRCUMSTANCES SHALL RYEGRASS, ITALIAN RYE OR ANY OTHER SEED BE ADDED TO THE SEED MIXTURE UNLESS APPROVED BY THE TOWN
- 2. WHEN TEMPORARY GRASS SEED IS REQUIRED, PERENNIAL RYEGRASS (LOLIUM PRENNE) SHALL BE APPLIED FROM MARCH 15 THROUGH
- OCTOBER 15.

 3. CONTRACTOR IS RESPONSIBLE TO PLACE ADDITIONAL LOAM, SEED, FERTILIZER AND/OR WATER AS NEEDED UNTIL GRASS IS ESTABLISHED TO THE SATISFACTION OF THE TOWN.

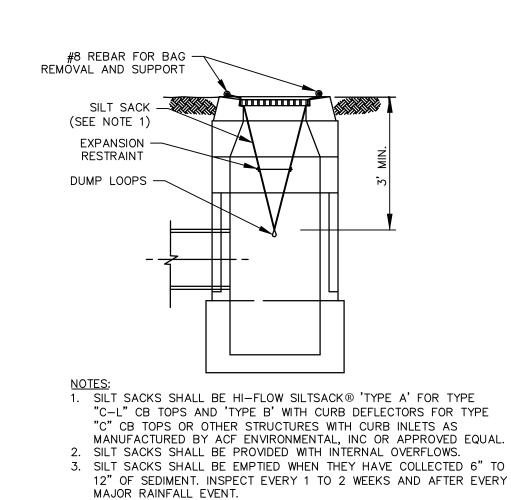

SILT SACK

NOT TO SCALE

RESTORATION OF LAWN AREAS



TOWN OF WETHERSFIELD
DEPARTMENT OF PUBLIC WORKS
ENGINEERING DIVISION
505 SILAS DEANE HIGHWAY
WETHERSFIELD, CT 06109

COMMUNITY CONNECTIVITY GRANT PROGRAM OLD WETHERSFIELD SAFETY IMPROVEMENTS

				REVISIONS		
				COMMENTS	E	No.
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05/19/22 Sheet No.	DATE:	JM	DRAWN BY:			
1" = 120' OR	SCALE:	JM	CHECKED BY:			
AS NOTED I Z Of I Z	AS NOTED I C of	APPROVED BY: DG		C.DWG	XXXX.DWC	DWG FI